2014 Legislature TPS Report 55951v1

Agency: Commerce, Community and Economic Development

Grants to Named Recipients (AS 37.05.316)

Grant Recipient: Wrangell Cooperative Association Federal Tax ID: 92-6000144

Project Title: Project Type: New Construction and Land Acquisition

Wrangell Cooperative Association - Carving Facility

State Funding Requested: \$515,000 House District: 33 / Q

One-Time Need

Brief Project Description:

Construction of a Carving Facility by the Wrangell Cooperative Association to be located next to the SNO Building and Wrangell Museum in downtown Wrangell

Funding Plan:

Total Project Cost: \$1,000,000
Funding Already Secured: (\$485,000)
FY2015 State Funding Request: (\$515,000)
Project Deficit: \$0

Funding Details:

Wrangell Cooperative Association has secured 485,000 toward this project through private foundations. The project has begun but lacks the funds for final completion.

Detailed Project Description and Justification:

The goal of this project is to construct a carving facility in downtown Wrangell. With the assistance of the Foraker Group, Wrangell Cooperative Association (WCA) developed a strategic plan. This plan describes how the tribe intends on generating revenue to maintain the recently completed Chief Shakes House and future tribal programs and projects, including this proposed new carving facility. The carving facility, in conjunction with the newly reconstructed and rededicated Chief Shakes Tribal House, will provide tourism and educational opportunities alike. These tribal assets will enhance a visitor's experience in the community and potentially drive more visitors to the community of Wrangell and generate more revenue for the tribe and the community as a whole. WCA has also applied for an ANA grant to operate the facility for two years while external revenue sources are developed.

Page 1

Project Timeline:

Upon receipt of funds, completing construction of the carving facility would occur immediately.

Entity Responsible for the Ongoing Operation and Maintenance of this Project:

WCA

For use by Co-chair Staff Only:

\$50,000 Approved 2014 Legislature TPS Report 55951v1

(Grant Recipient Contact Information:					
П	Name:	Ernie Christian				

Title: President Address: PO Box


Wrangell, Alaska 99929

Phone Number: (907)874-2222

Email:

Has this project been through a public review process at the local level and is it a community priority? X Yes No

Contact Name: Becky Rooney Contact Number: 465-4858

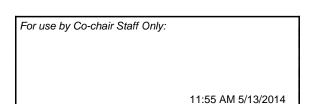



Wrangell Cooperative Association

104 Lynch St. Wrangell, Alaska 99929

Mailing Address: P.O. Box 2021 Wrangell, AK 99929

Telephone: 907-874-4304 Fax: 907-874-4305

Email: wcatribe@gmail.com

Date: 10/9/12

Re: Capital Projects

Wrangell Borough Assembly City and Borough of Wrangell PO Box 531 Wrangell, Alaska 99929

Honorable Mayor and Members of the Assembly,

The Wrangell Cooperative Association would like to first thank you for your commitment to secure funding for the Chief Shake's House Restoration Project. Without the support of the Borough Assembly and city staff, we would not have been able to reach our fundraising goal.

Wrangell Cooperative Association would like to take this opportunity to articulate our long-term vision for cultural, social, and economic development for the tribe and the greater Wrangell community, and how the Chief Shake's House and the new carving facility contributes to this vision. We would also like to request that the next Borough State Capital Project List include a final request of \$500,000 to the State to complete the construction of a new carving facility to be located adjacent to the SNO Building in downtown Wrangell.

The carving facility will cost approximately \$1,000,000 to construct. We have secured approximately \$485,000 to date for the new facility, and would like to request \$500,000 from the State of Alaska. To strengthen our proposal, we respectfully request to be placed in the top ten capital projects for the City & Borough of Wrangell.

To give you an idea of how significant the restoration project has been in Wrangell, the project has raised and spent locally \$877,000 creating 18 jobs. In addition, we anticipate 600-1,000 people visiting Wrangell in May 2013 for the rededication of Chief Shake's House, which will generate a significant amount of revenue for local businesses.

Some of the restoration project and carving shed funding includes:

- \$150,000 Sealaska timber (donated)
- \$135,460 Carving shed land (50 year lease for \$1/year)
- \$250,000 State Appropriation
- \$500,000 State Appropriation

- \$222,000 Murdock Charitable Trust (Shakes Island)
- \$100,000 Paul Allen Foundation (new carving shed)-pending
- \$450,000 Rasmuson Foundation Shakes Island, Carving Shed and Project Development

With the assistance of Dennis McMillan, CEO of Foraker Group, the tribe developed a strategic plan. This plan describes how the tribe intends on generating revenue to maintain Chief Shake's House and future tribal programs and projects, including the new carving facility. The tribe intends on operating its own Chief Shake's tour operation in conjunction with tourism and education opportunities at the new carving facility. We believe these tribal assets will drive more visitors to Wrangell and generate more revenue for the tribe and the greater community. The tribe is applying for an ANA grant to operate the carving facility for two years while external revenue sources are developed.


We believe these projects are important for the cultural, social, and economic future of the tribe and the community of Wrangell. Coupled with our new front street, revitalization of the SNO Building, and all the other efforts around our community to make Wrangell a more beautiful place to live and visit, we believe our collective investment in the restoration of Chief Shake's House and the construction of the new tribal carving facility will contribute significantly to the growth of Wrangell.

Sincerel

Ernie Christian President

WRANGELL CARVING SHED


Wrangell Cooperative Association and Alaska Native Sisterhood

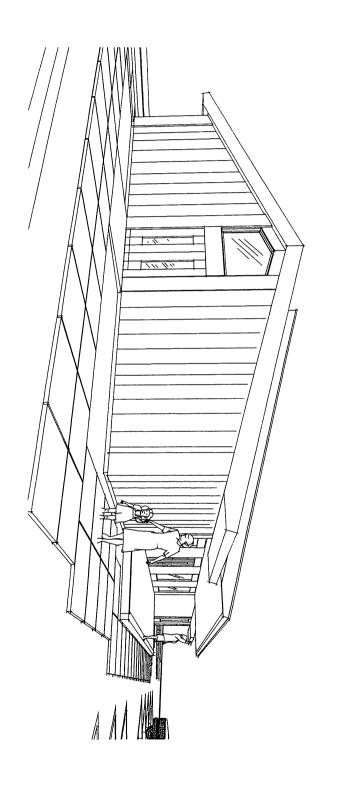

MRV Architects

Sept 10, 2012

WCA wrangell, alaska

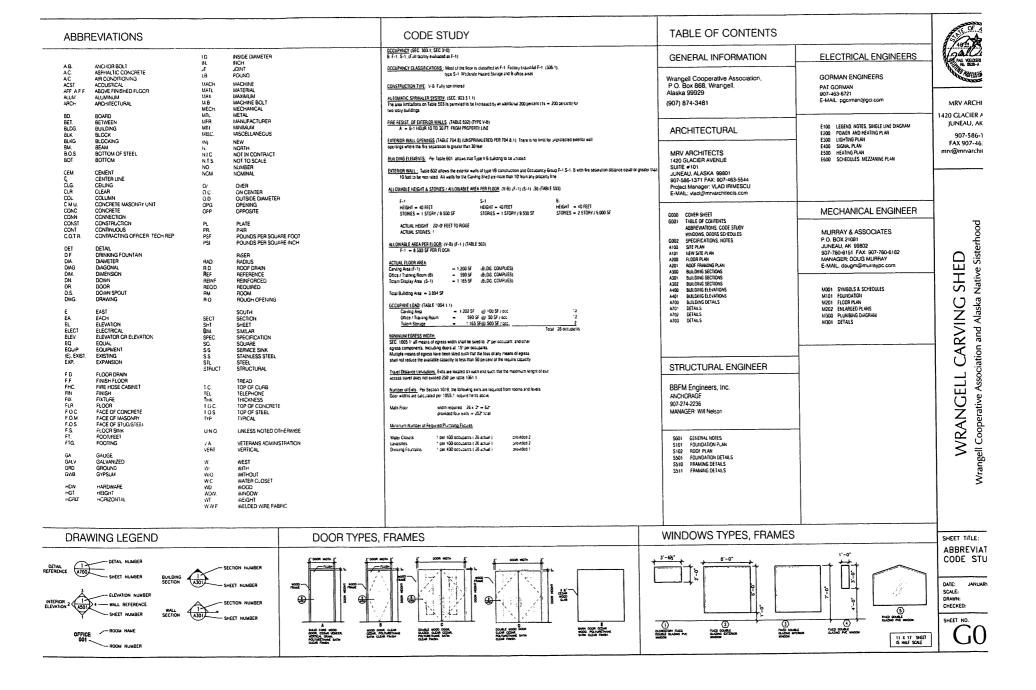

GEHÈRAL Reference structural drawings for building structure details and other leatures not indicated required. CAST-IN-PLACE CONCRETE

FOUNDATION DRAINAGE

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Metal Roof Warranty Requirements

The rooling manufactures shall provide a written warranty to the owner for all roof panels and associated trim materials to be tree of builts, defects and constron for minimum of 20 years in accordance with their standard provisions.

Door nationate snall be heavy dury months locks typic t-series statiness steet, with hend tevers model 0.3 tinksh 630, set as manufactured by Schlage. Key all doors allife and furnish the (5) sets of keys. Existic doors shall be of red or yellow cedar custom construction conform with drawings, all interior doors will be wood solic core flush type or as indicated in the drawings.

Wood Doors: Vancouver Doors PO Box 1418 Puyallup, WA 98371 1-253-845-9581

Door Types

B: Commercial Solid Core Door 520P clear codar veneer, clear satio linish A: Commercial Solid Core Door 520P, clear cedar veneer, satin finish 3' wide 3' ride

D: Commercial Solid Core Door 520P, clear maple veneer, clear, saith linush C. DOUBLE FOLDING DOOR, Sollo wood, vertical grain clear, saltn tirden width; veries, see plan

Wood Frames 3" wide

LOUVERS GRILLES

All founds and grides shall be stainless sieel 14 gauge, scaln finish as manulaculied by Archiectural Gille. 42 Second Avenue. Brooklyn. New York 11215. Tel. (800)- 387-6267 or approved simila/equal.

Door Hardware rames SCHLAGE D Series RHO 626 - Phodes 626 Phone. 1-800-847-1864 Fax. 1-800-452-0663

PANTS

Provide linushed painled surfaces for all gypsum board, substrates and wood surfaces

Save of design is spanied by Belgianin Moote & Co. Metrose Park. Illinois (B-M). Other products will be reviewed that equivalency. Part calons as selected by Architect. Colors: Vorospaney, Week U. 33 Chesteriane But nC-9

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American Speculies, inc NVI Hardware Consultants 1021 207th Place S.E. Bichell, Wa 98012 2d Sines Tel: 425 402 4242 Fax: 425 427

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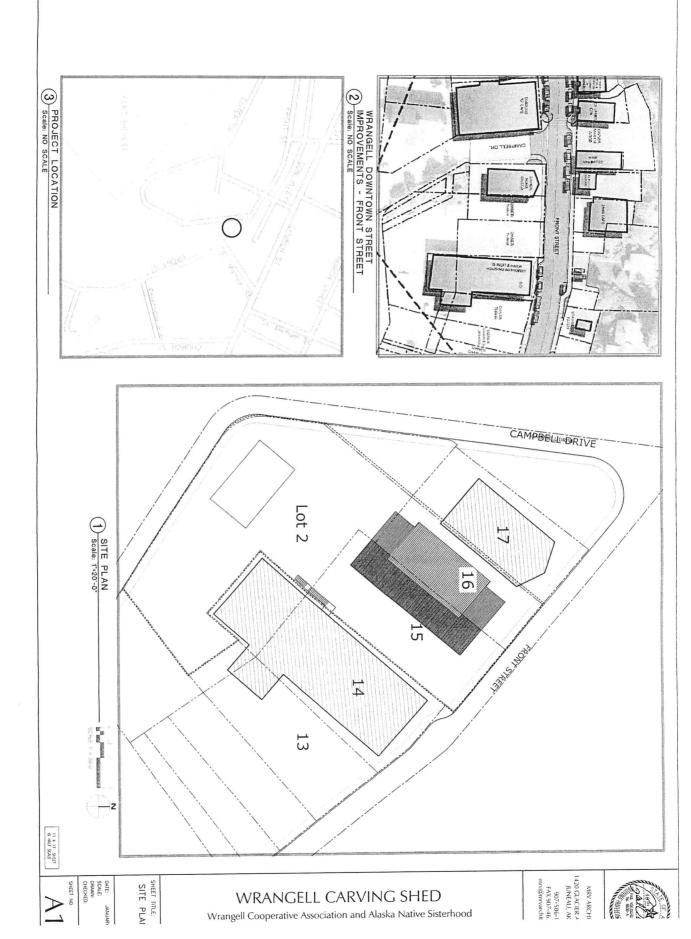
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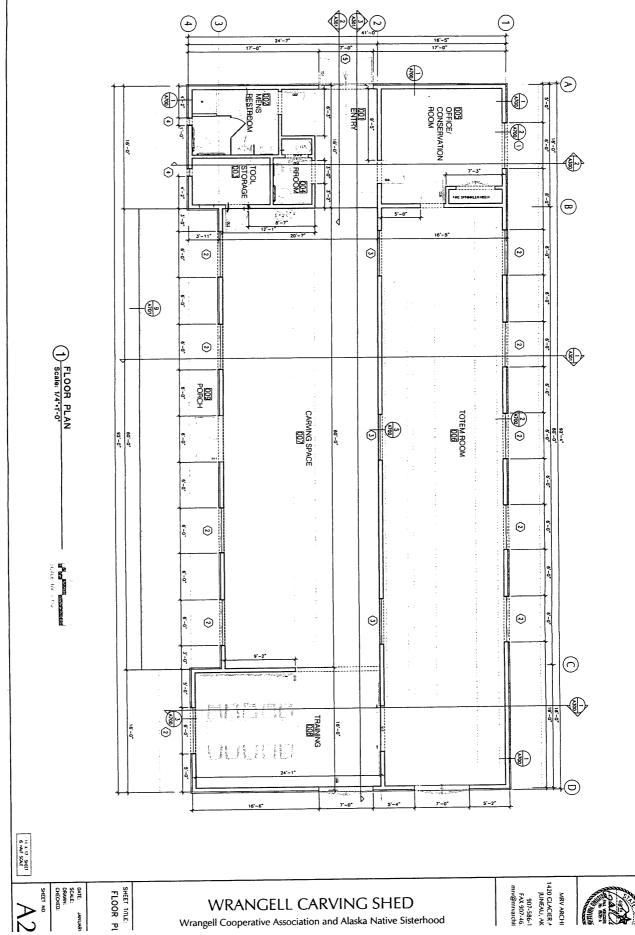
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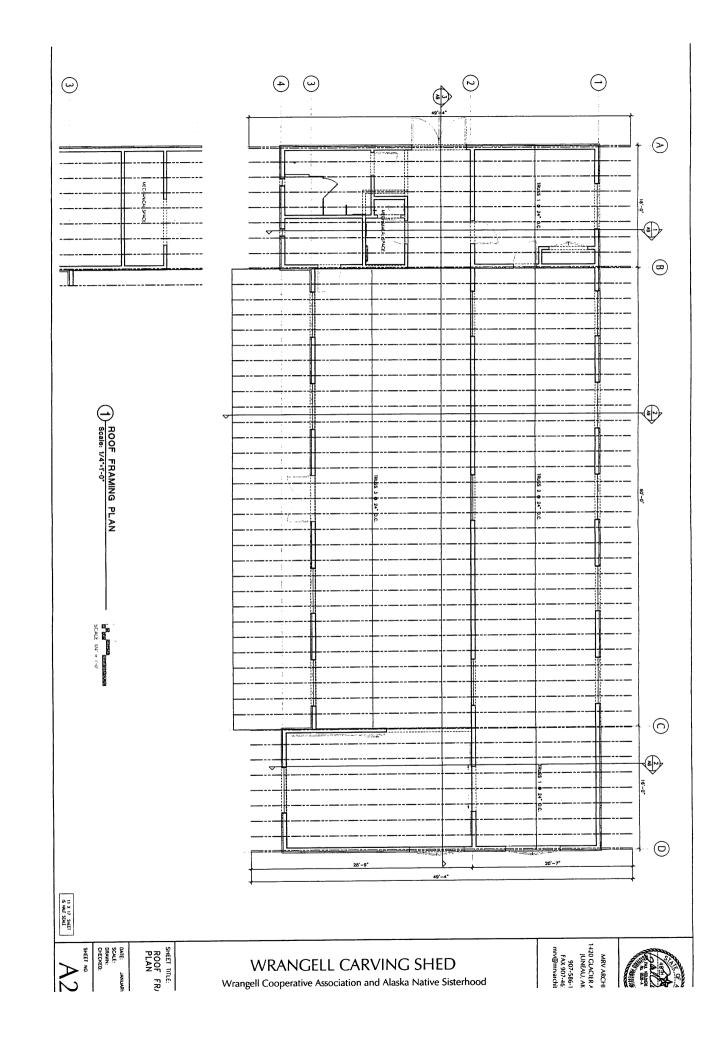
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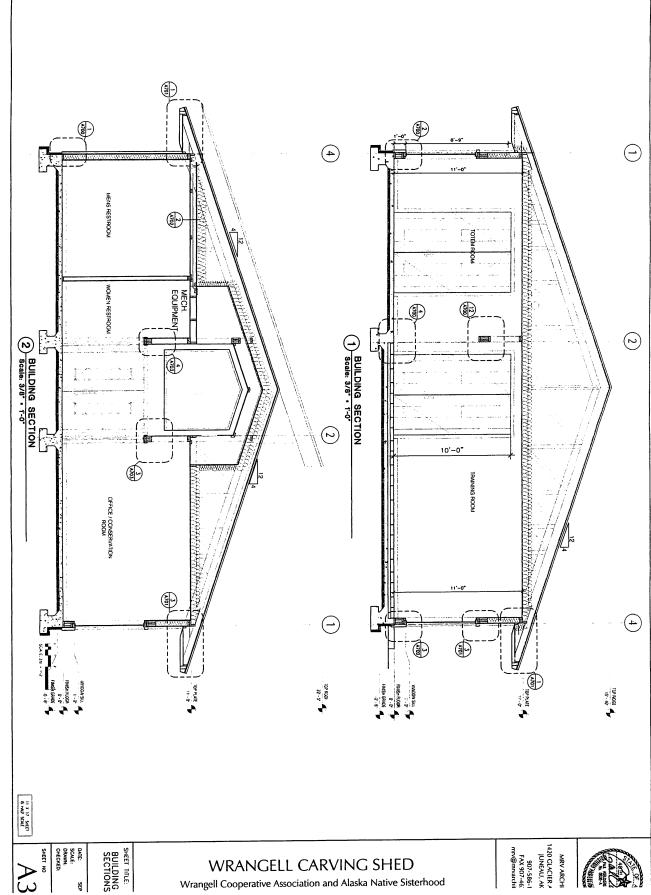
WRANGELL CARVING SHED Wrangell Cooperative Association and Alaska Native Sisterhood












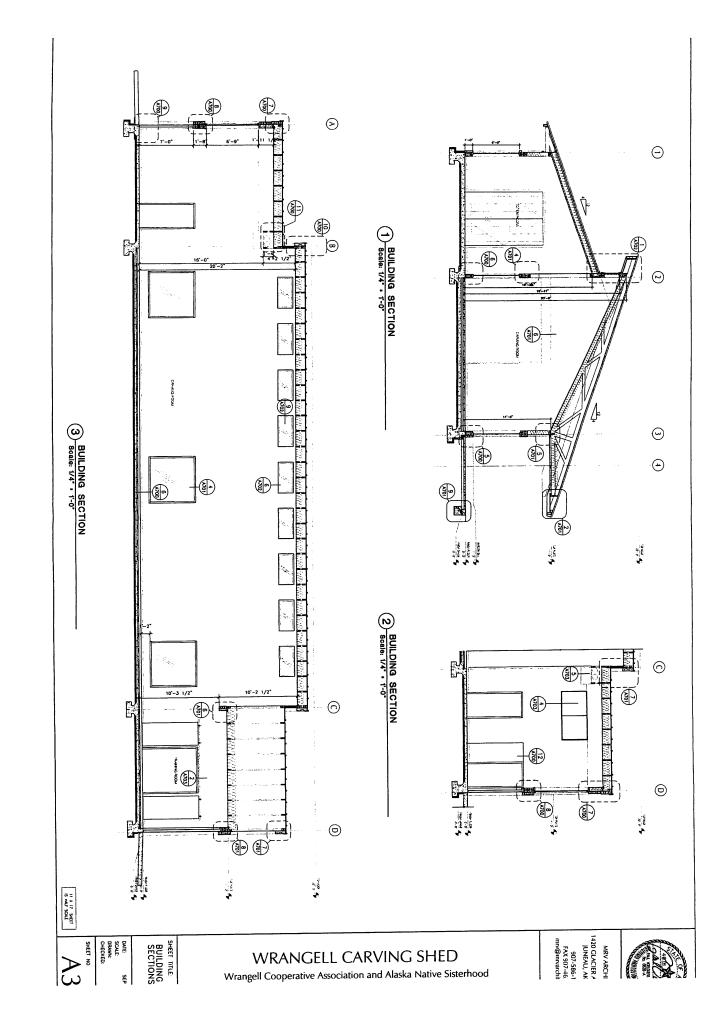

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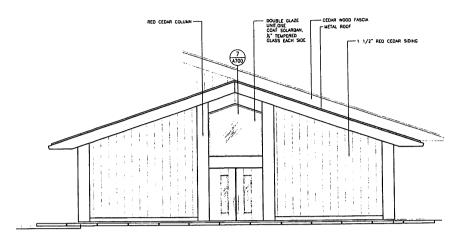
WRANGELL CARVING SHED Wrangell Cooperative Association and Alaska Native Sisterhood

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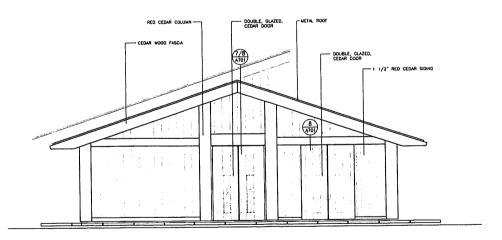
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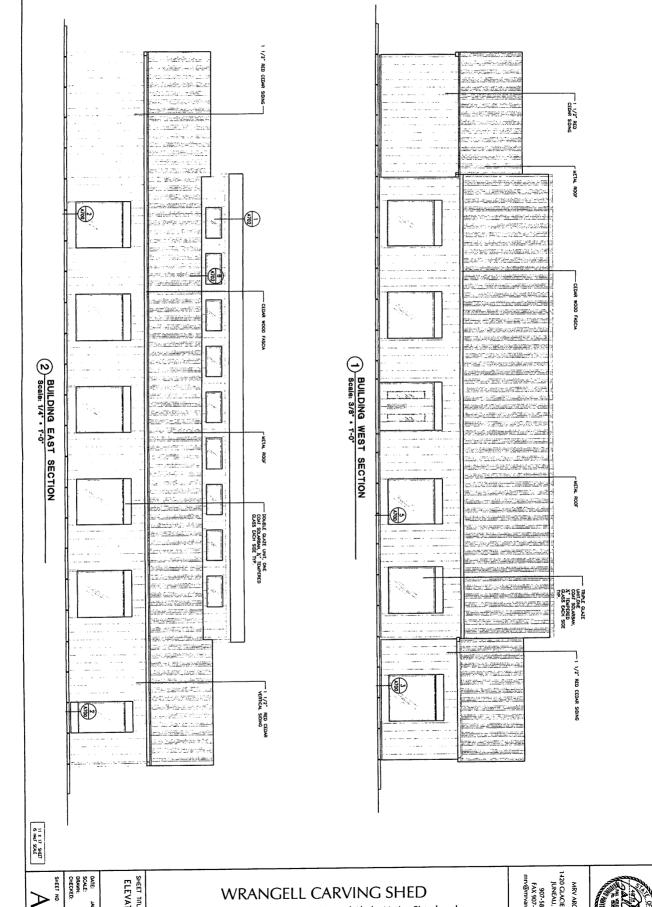
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BUILDING FRONT ELEVATION Scale: 1/4" • 1'-0"




BUILDING BACK ELEVATION
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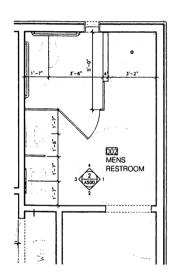


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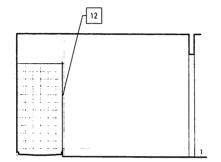






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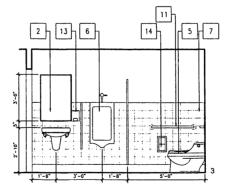


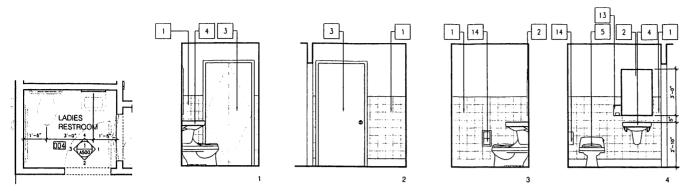MENS RESTROOM FLOOR PLAN AND ELEVATIONS 2 Scale: 1/2" • 1'-0"





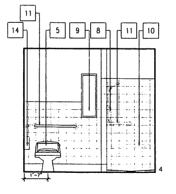

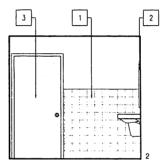

LEGEND

- 1. PORCELAIN TILE
- 2. 24" X 36" SS FRANED MIRROR
- 3. DOOR PAINT
- 5. WATER CLOSET
- 7. G.B. PAINT
- FIXED WINDOW
- 11. GRAB BAR W/HORIZ. BLOCKING IN WALL
- 12. SHOWER GLASS DOOR
- 13. SOAP DISPENSER
- 14. TOILET PAPER DISPENSER



MRV ARCHI 1420 GLACIER /

JUNEAU, AK 907-586-1 FAX 907-46.

mrv@mrvarchit


Wrangell Cooperative Association and Alaska Native Sisterhood WRANGELL CARVING SHED


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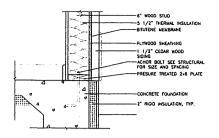
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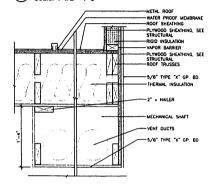
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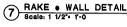
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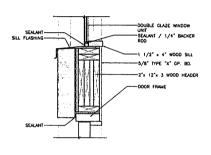
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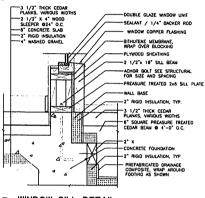
TOP BEAM . WALL DETAIL 10 TOP BEAM •






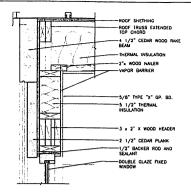


TOTEM STORAGE & CARVING AREA DETAIL 4 Scale: 1 1/2** 1'-0

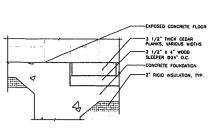


EXT. WALL . FOUNDATION DETAIL Scale: 1 1/2" 1'-0

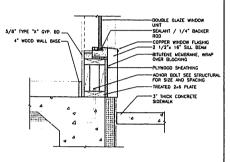


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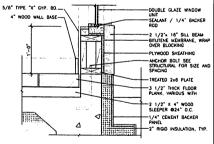
8) TOP BEAIN -TOP BEAM . WALL DETAIL

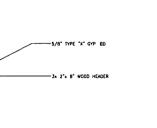

Scale: 1 1/2** 1'-0 WINDOW SILL DETAIL

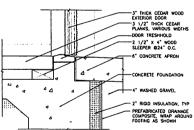

WINDOW SILL DETAIL (2) WINDOW SILL Scale: 1 1/2** 1'-0

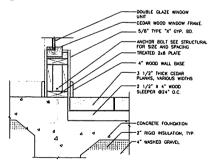



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SHEET NO.

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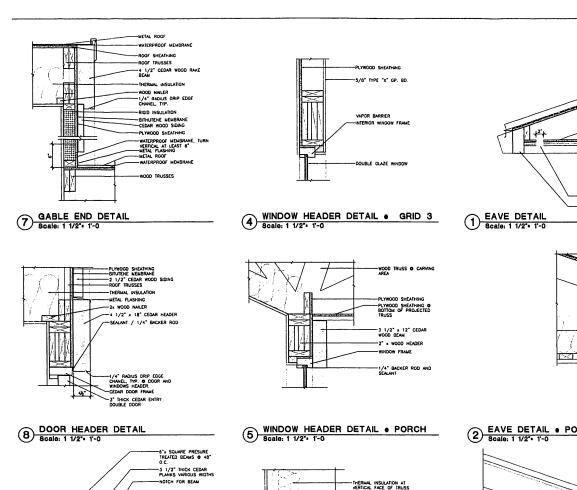
9 Scale: 1 1/2": 1'-0 TRANSITION DETAIL AT EXIT


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Wrangell Cooperative Association and Alaska Native Sisterhood 3 WRANGELL

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I" NUT & FEDER CEDAR-PLANKS @ SOFFIT

-2" VENT , SCREENED -3 1/2" CEDAR FASCIA



MRV ARCHI 1420 GLACIER A JUNEAU, AK

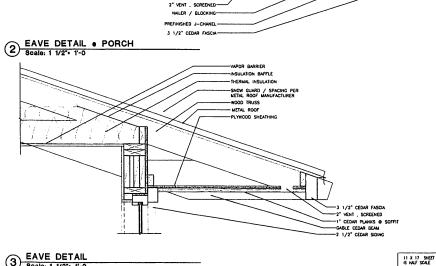METAL ROOF

-wood TRUSS

-VAPOR BARRIER

-INSULATION BAFFLE

-PLYWOOD SHEATHING

-THERMAL INSULATION

-5/8" TYPE "X" GP. BD.

-1" NUT & FEDER CEDAR PLANKS @ SOFFIT

-PLYWOOD SHEATHING

-1/2" CEDAR SIDING -GABLE CEDAR BEAM

THERMOINSULATION BAFLE NON PERFORATING SNOW GUARD
 METAL ROOF

- PLYWOOD SHEATHING

-2 x BLOCKING SEE STRUCTURAL

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SHED

Wrangell Cooperative Association and Alaska Native Sisterhood WRANGELL CARVING

SHEET TITLE: DETAILS

DATE: SCALE: DRAWN: CHECKED:

SHEET NO.

EDGE OF PORCH DETAIL 9 Scale: 1 1/2's 1'-0

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-12"x12" PRESURE TREATED BEAM

BEAM . WALL DETAIL 6 BEAM • WOLLE


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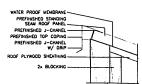
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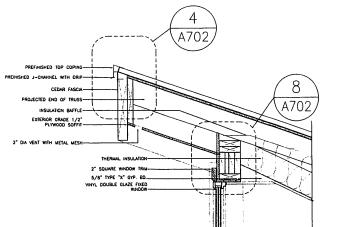
-4" SSTEEL BEARINGS -DOOR HARDWARE: "BALDUR 8" -SSTEEL 2"x3/4" RAIL

-THERMAL INSULATION -12"x 7" CEDAR WOOD BEAM -VAPOR BARRIER -5/8" TYPE "X" GP.80

(3) Scale: 1 1/2*- 1'-0





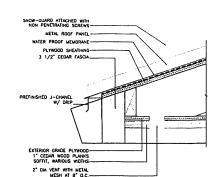

2" SQUARE WINDOW TRIM

PRE-MANUFACTURED VENT METAL ROOF



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SHED WRANGELL CARVING

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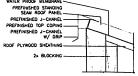
Wrangell Cooperative Association and Alaska Native Sisterhood

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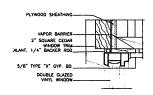
DETAILS


SHEET NO.



7 DETAIL • E DETAIL . EAVE

TOP COPING DETAIL 4 Scale: 3° 1'-0



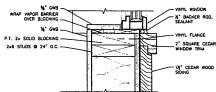

2" SQUARE CEDAR WINDOW TRIM 1½° CEDAR WOOD SIDING

HEADER . CLERESTORY Scale: 3": 1'-0

> 5/8" TYPE "X" GYP. 80. VINYL WINDOW

SEALANT, 1/4" BACKER ROD

BITHUTENE MEMBRANE WRAP AROUND BLOCKING


R 20 THERMAL INSULATION


1 1/2" THICK CEDAR SIDING


2" SQUARE CEDAR WINDOW TRIM-

PLYWOOD SHETHING

JAMB . CLERESTORY 5 Scale: 3** 1'-0

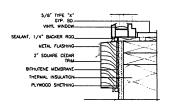

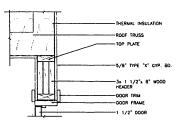

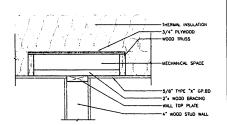


JAMB DETAIL . CLERESTORY Scale: 3". 1'-0

6 SILL DETAIL • CLERESTORY

DETAIL 3 Scale: 1 1/2's 1'-0 2 FLOOR & WALL CONNECTION Scale: 1 1/2** 1'-0

DETAIL • CLERESTORY
Scale: 1 1/2*• 1'-0

II X 17 SHEET IS HALF SCALE

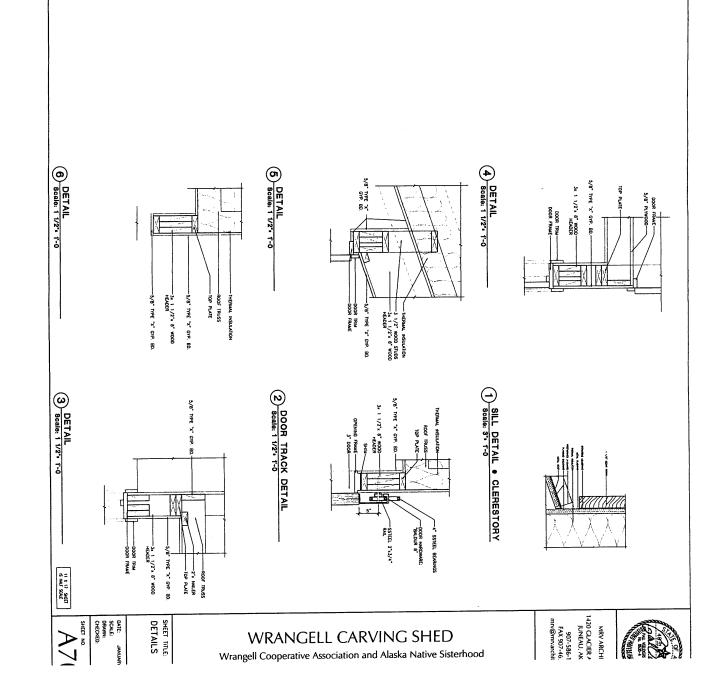

T	JRAL NOTES
	<u>PLYW000:</u>
	ROOF SHEATHING-PLYWOOD GRADE STRUCTURAL I, CD INT-APA WITH EXTERIOR GLUE LAID FACE GRAIN PERPENDICULAR TO SUPPORT - 34° THICK.

NAILING AT ROOF PANEL EDGES 104 @ 6" OC. INTERMEDIATE SUPPORTS 104 @ 12" OC

NAILING AT WALL PANEL EDGES 8d @ 8° OC, EXCEPT SEE SHEARWALL SCHEDULE. INTERMEDIATE SUPPORTS 8d @ 12° OC.

WEB AND CHORD SIZES INDICATED ON PLANS ARE MINIMUM ORLY. ROOF DESIGN DEAD LOAD - 15 PSF MINIMUM, ROOF DESIGN WIND UPLIFT - 35 PSF MINIMUM. DESIGN TRUSSES FOR SUPPORT OF DEAD.

MARIBUM, NOTO DESIGN WITHOUT LIVE SHOP DRAWNINGS SHOWING TRUSSES AND ERECTION LIVE, SHOW DRIFT AND WIND LOADS. SUBJIAT SHOP DRAWNINGS SHOWING TRUSSES AND ERECTION BRACING SIZES AND CONNECTIONS. SHOP DRAWNINGS SHOWING TRUSSES AND ERECTION BY A PROFESSIONAL ENGINEER LICENSED IN STATE OF ALASKA, PROVIDE DRAWNINGS FOR ERECTION

WOOD TRUSSES DESIGNED, MANUFACTURED AND INSTALLED PER TRUSS PLATE INSTITUTE

MRV ARCHI 1420 GLACIER A

JUNEAU, AK 907-586-1 FAX 907-46 mrv@mrvarchit

Native Sisterhood SHED Alaska CARVING Wrangell Cooperative Association and WRANGELL

GENERAL

SEPTEMBE CHECKED:

SHEET NO.

THE FOLLOWING NOTES APPLY UNLESS INDICATED OTHERWISE:

INTERNATIONAL BUILDING CODE, 2006 EDITION.

DESIGN SOIL PRESSURE:

3000 PSF MAX DEAD + LIVE LOAD

CAST FOOTINGS ON COMPACTED EXISTING SUBGRADE, 2-0" MINIMUM BELOW FINISHED GRADE. CAST SLAB ON GRADE OVER 6" THICK COMPACTED GRANULAR FILL OVER COMPACTED SUBGRADE.

Pg = 60 PSF, Ps = 45 PSF Ca = 0.9, i = 1.0, Ct = 1.2

SNOW DRIFT

ROOF

WIND

ASCE 7-05, CHAPTER 7 120 MPH 3-SECOND GUST

I = 1.0, EXPOSURE D BUILDING CATEGORY I (GCpl) = 0.18, qh = 32.3 1 = 1.0 SEISHIC LISE GROUP II

SEISMIC

8s = 0.17, S1 = 0.15 SOIL SITE CLASS D Sds = 0.18, Sd1 = 0.22, SEISMIC DESIGN CATEGORY D BASIC SEISMIC FORCE RESISTING SYSTEM: PLYWOOD SHEAR WALL

REINFORCED CONCRETE:

ALL CONCRETE - fc = 3000 PSI, MINIMUM 6 SACKS OF CEMENT PER CUBIC YARD. SUBMIT MIX DESIGN.

UNLESS OTHERWISE NOTED, REINFORCING STEEL SHALL CONFORM TO ASTM A615, GRADE 50. PROVIDE CLASS B SPLICE. SUBMIT REINFORCING STEEL SHOP DRAWINGS WITH DETAILS PER ACI 315

WELDED WIRE FABRIC PER ASTM A185. FURNISH IN FLAT SHEETS, NOT ROLLS. LAP EDGES 1 1/2 MESH

CONCRETE COVER:

FOOTINGS 3°. SLABS ON GRADE 1 1/2°

FOOTINGS:

PROVIDE CORNER BARS OF SAME SIZE AND NUMBER AS LONGITUDINAL REINFORCING AT CORNERS AND INTERSECTIONS, 30° LAP EACH LEG.

RIGIDLY SUPPORT REINFORCING WITH CONCRETE BLOCKS OR APPROVED ACCESSORIES. REINFORCE WITH WS WELDED WIRE FABRIC WITH 4 INCH MESH 2" FROM TOP.

ANCHOR BOLTS, ASTM F1554 GRADE 36.

GLUED-LAMINATED TIMBER:

BEAMS AND GIRDERS - DOUGLAS FIR SPECIES, COMBINATION 24F-V4. APPEARANCE - CONSTRUCTION

PARALLEL STRAND LUMBER (PSL):

COLUMNS AND POSTS - 1.8E. Fb = 2400 PSI BEAMS AND HEADERS - 2.0E, Fb = 2900 PSI

STRUCTURAL SAWN LUMBER:

LUMBER VISUALLY GRADED AND STAMPED PER WWPA STANDARD GRADING RULES. MOISTURE CONTENT OF LUMBER 2" OR LESS IN THICKNESS - 19 PERCENT MAXIMUM.
HEM-FIR SPECIES, #2 GRADE OR BETTER, F5 = 850 PSI.

CONVENTIONAL CONSTRUCTION PROVISIONS PER SECTION 2308 OF THE IBC. MINIMUM NALLING FOR CONVECTION OF VARIOUS COMPONENTS PER TRAILE 2304, 9.1 OF THE IBC. TREAT WOOD BEARING ON OR WITHIN 1' OF CONCRETE WITH PRESERVATIVE. USE HILD STEEL PLATE WASHERS AT ALL BOLT THEADS AND WITH SEARING ON WOOD. ATTACH FOUNDATION PLATES AND SILLS TO CONCRETE WITH CALVANIZED BOLTS. USE COMMON NALIS OILLY. USE HOT-DIPPED GALVANIZED FASTENERS IN ALL PRESERVATIVE TREATED AND FIRE RETARDENT TREATED WOOD. USE GALVANIZED FRAMING HARDWARE MANUFACTURED BY SIMPSON COMPANY OR APPROVED EQUAL.

MISCELLANEOUS:

WALL SHEATHING - 7/16" THICK OSB.

METAL PLATE CONNECTED WOOD TRUSSES;

SPECIFICATIONS. ICC-ES CERTIFICATION REQUIRED

DRAWINGS INDICATE GENERAL AND TYPICAL DETAILS OF CONSTRUCTION. WHERE CONDITIONS ARE NOT SPECIFICALLY INDICATED BUT ARE OF SIMILAR CHARACTER TO DETAILS SHOWN, SIMILAR DETAILS OF CONSTRUCTION SHALL BE USED SUBJECT TO REVIEW AND APPROVAL BY THE ARCHITECT

REFER TO ARCHITECTURAL DRAWINGS FOR WALL OPENINGS

SHEET TITLE:

DATE: SCALE:

II X 17 SHEET IS HAUF SCALE

ABOVE ANCHOR BOLT AMERICAN CONCRETE INSTITUTE FLOOR DRAIN FOUNDATION FINISH, FINISHED FAR FACE FON FIF FLORES FIF FLORES ADDL ADDITIONAL AGGREGATE FLANGE FLOOR AGGR AISC PL PLCS PLWD AGGREGATE
AMERICAN INSTITUTE OF
STEEL CONSTRUCTION
AMERICAN INSTITUTE OF
TIMBER CONSTRUCTION
ALTERNATE
ALUMINUM
ARCHITECT, ARCHITECTURAL FACE OF STUDS FIRE RETARDANT TREATED
FAR SIDE
FOOT, FEET AITC P/S PSF PSI PSL PT P/T FOOTING FUTURE ALUM FIELD VERIFY **@** APPROX AT
APPROXIMATELY
AMERICAN SOCIETY OF
CIVIL ENGINEERS
AMERICAN SOCIETY FOR
TESTING AND MATERIALS
AMERICAN WELDING GAUGE, GAGE GENERAL GLUE LAMINATED R RD REF REINF ASTM GL GND GR GB GYP GROUND AWS GRADE GYPSUM BOARD SOCIETY HDG HORIZ HP HOT DIPPED GALVANIZED BOTTOM (BEAM AND JOIST SCHEDULES ONLY) HORIZONTAL HP STEEL SHAPE BOARD BUILDING LINE BD BLKG BLKG BM BOD BOT BRG BSMT BTWN

HSB HSS HT

IBC

ICF ID

IN OR

INCL INSUL INT

JT JST

K KSI

LB OR E LGS LLBB LLH LLV LONGIT LRFD

LSLT LSLT LT LT WT LVL LVF

M MAS MATL MAX MECH MFR MFRG MIN MISC MT

MTD MTL

N NF NFS NIC No OR I NOM NS NTS

OA OC OD OF OPNG OPP OSB

ovs

LIGHT WEIGHT LAMMATE VENEER LUMBER LOW VELOCITY FASTENER

MISCELLANEOUS SHAPE

STRUCTURAL TEE FROM M SERIES SECTION MOUNTED

NORTH
NEAR FACE
NON FROST SUSCEPTIBLE
NOT IN CONTRACT
NUMBER
NOMINAL
NEAR SIDE

NOT TO SCALE

ON CENTER OUTSIDE DIAMETER OUTSIDE FACE

ORIENTED STRAND

BOARD OVERSIZED HOLES

OVERAL!

OPPOSITE

MASONRY MATERIAL MAXIMUM

MAXIMUM MECHANICAL MANUFACTURER MANUFACTURING MINIMUM MISCELLANEOUS

(A) AB ACI

BEAM BOTTOM OF DECK

AMERICAN CHANNELS CENTER OF GRAVITY

CONSTRUCTION JOINT
COMPLETE JOINT PENETRATION
CAST-IN-PLACE
CENTER LINE
CEILING

CONCRETE MASONRY UNIT CONCRETE OPENING COLUMN

BOTTOM BEARING BASEMENT BETWEEN

CONCRETE

CENTER COUNTERSUNK

DETAIL DIAMETER

DITTO

EXISTING

ELECTRICAL

ELEVATOR

ENCLOSURE

EQUAL EQUIPMENT EACH SIDE EACH WAY EXISTING

EDGE OF DECK

FYPANSION BOLT

EACH FACE EXPANSION JOINT

ELEVATION (HEIGHT)

CONCRETE
CONNECTION
CONSTRUCTION
CONSTRUCTION
CONTRACTOR
CONTRACTOR
CONTRACTION JOINT

DOUBLE DEMAND CRITICAL DEPARTMENT

DRILLED-IN ADHESIVE BOLT DIAGONAL
DIAPHRAGM
DRILLED-IN EXPANSION BOLT
DIMENSION
DOMAI

CTR CTSK CU

DBL DC DEPT DIA, Ø DIAB DIAG DIAPH DIEB DIM DN do DP DWG DWL

E (E) EA EB EF X) ELECY ENGRESON EXIST EXP

S SCHED SECT SH PL SHT SHTHG HIGH STRENGTH BOLT HOLLOW STRUCTURAL SECTION HEIGHT INTERNATIONAL BUILDING SIM INSULATED CONCRETE FORM INSIDE DIAMETER INSIDE FACE SLBB INCLUDE INSULATION, INSULATED

SMS SOG SP SPA SLAB ON GRADE SPIRAL SPACE, SPACING, SPACES SPECIFICATION SPEC SQ SS SSLT ST SQUARE STAINLESS STEEL SHORT SLOTTED HOLE STRUCTURAL TEE FROM S SERIES SECTION KIPS PER SQUARE INCH ANGLE
POUND
LIGHT GAGE STEEL
LONG LEG BACK TO BACK
LONG LEG HORIZONTAL
LONG IEG WESTECAL
LONG IEG WESTECAL
LONG IGTUDINAL
LONG HORIZONTAL
LONG HORIZONTAL
LONG HORIZONTAL
LONG HORIZONTAL
LONG HORIZONTAL
LONG STOTED HOLES
LONG SLOTTED HOLES
LIGHT STD STIFF STIRR STL STRUCT SUPT SUSP SYMM STIFFENER STIRRUP STRUCTURAL SUPPORT SUSPENDED SYMMETRICAL

PRECAST

PLATE (WOOD) PLACES PLYWOOD

PRESTRESSED

POST TENSION

RADIUS ROUND REFERENCE

REINFORCING.

REINFORCEMENT, REINFORCED

AMERICAN STANDARD

STEEL SHAPE, SOUTH

STRUCTURAL INSULATED PANEL SHORT LEGS BACK

TO BACK SHEET METAL SCREW

SCHEDULE SECTION SHEAR PLATE

SHEET SHEATHING

SIMILAR

PLATE CONNECTED WOOD TRUSS
PERPENDICULAR
PARTIAL JOINT PENETRATION
PLATE (STEEL)

PRESTRESSED
POUNDS PER SQUARE FOOT
POUNDS PER SQUARE INCH
PARALLEL STRAND LUMBER
PRESERVATIVE TREATED

T TC T&G TEMP TOP OF CURB TONGUE AND GROOVE TEMPERATURE, TEMPORARY THK THRU TOC TOF TOS TOW TRANS TYP THICK THROUGH TOP OF CONCRETE TOP OF FOOTING TOP OF STEEL TOP OF WALL TRANSVERSE TYPICAL

UL

UON UT

VEF VERT VIF VOF

W/O W/O W/H W/HS W/P W/S W/S W/T

WTS WWF

VERTICAL EACH FACE VERTICAL VERTICAL INSIDE FACE VERTICAL OUTSIDE FACE WEST, W SERIES SECTION WITH WITHOUT

UNDERWRITERS


AROBATORY


WORK POINT WATERSTOP WEIGHT, STRUCTURAL TEE FROM W SERIES SECTION WELDED THREADED STUD WELDED WIRE FABRIC

UNLESS OTHERWISE NOTED

WOOD WEEP HOLE WELDED HEADED STUD

YARD

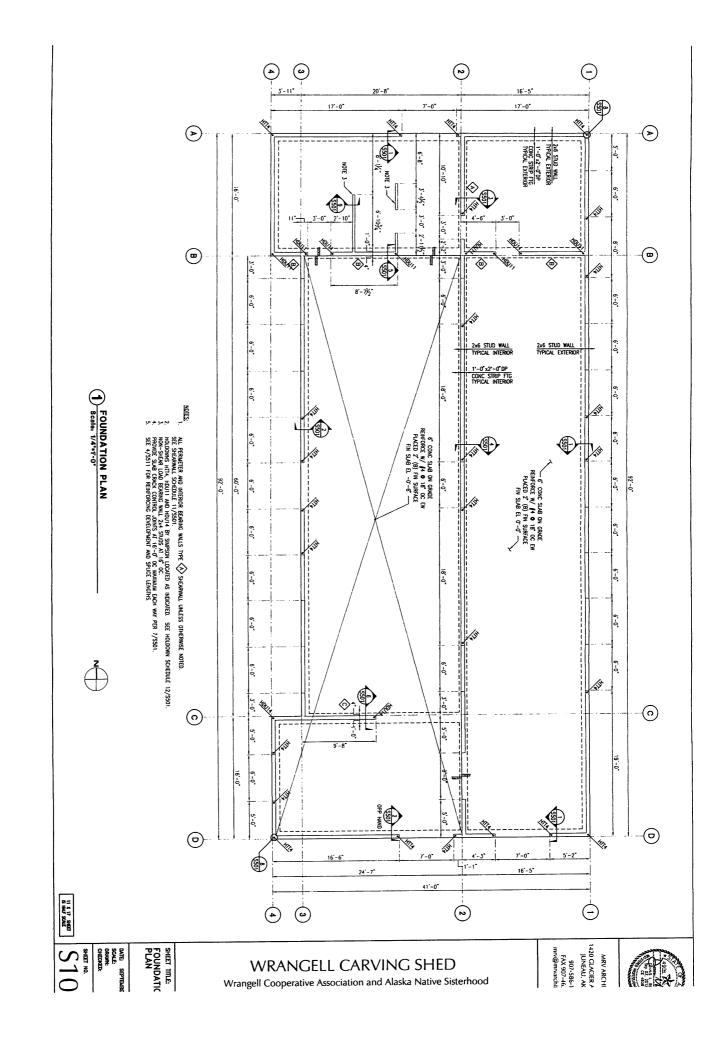

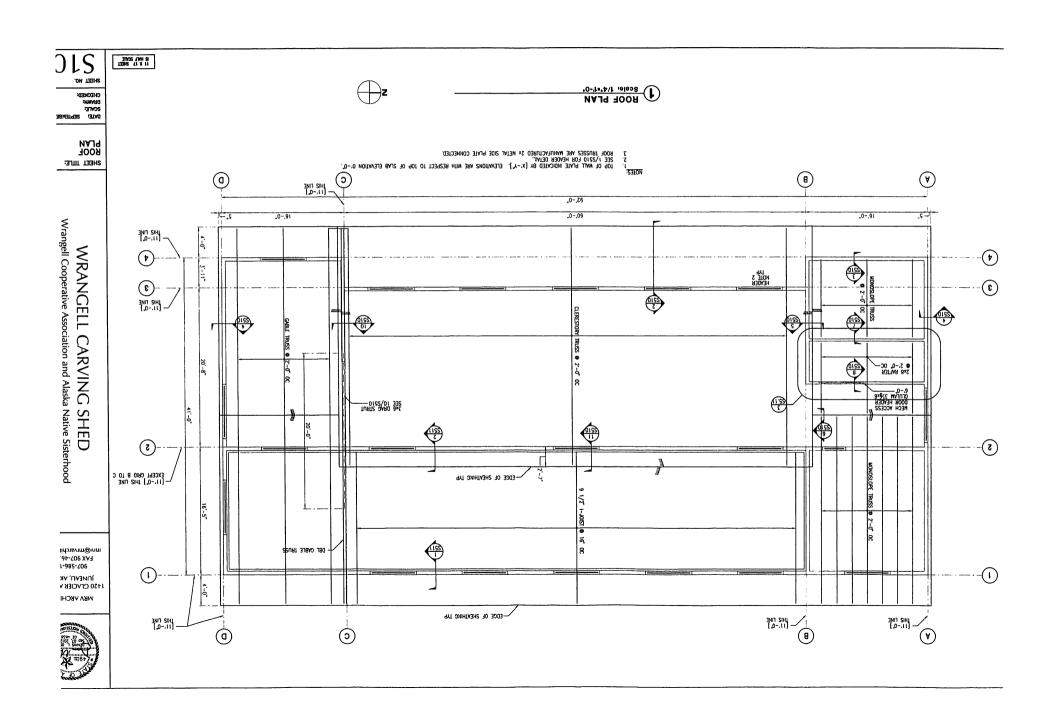










SHEET TITLE: FOUNDATI DETAILS


DATE: SEPTEMBE SCALE: DRAWN: CHECKED:


SKEET NO.

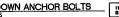

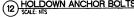

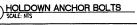

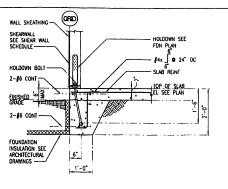

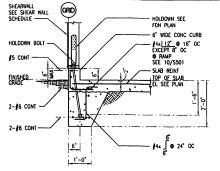


2 PERIMETER CURB SCALE: 3/4" = 1'-0"


3-#4x WITHIN

HOLDOWN BOLT

4" EACH SIDE OF

(C)

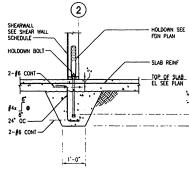

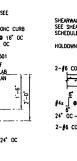

HOLDOWN SEE

HOLDOWN BOLT

FON PLAN

-2-16 CONT


SLAB REINF


2-#6 CONT


4x **∫ 6** 16 ° OC


S GRID C EXCEPT 3 WITHIN 4" OF HOLDOWN

PLANKING PER ARCH

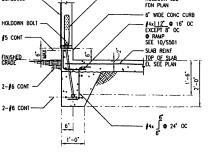

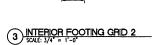

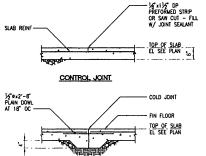

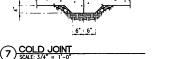

SHEAR WALL SCHEDULE

PROVIDE $3^{*}x3^{*}x^{1}/4^{*}$ PLATE WASHERS ON TOP OF ALL SILL PLATES AT ANCHOR BOLTS.

SIMPSON HOLDOWNS AND STRAPS ARE INDICATED ON PLANS. PROVIDE 2x FLAT BLOCKING AT HORIZONTAL JOINTS BETWEEN STUDS.

6. PROVIDE PANEL EDGE NAILING AT STUDS WITH HOLDOWNS.

SHEATHING MAY BE INSTALLED EITHER VERTICAL OR HORIZONTAL

3x

3x

3x SILL, 5/8" AB @ 16"

PANEL EDGE FRAMING AT NAILING PANEL JOINTS

8d 9 6 OC

8d • 3 OC

8d 9 3° OC

SHEATHING SQUARE EDGED OSB.


TYPE SHEATHING

6

ONE SIDE

ONE SIDE

TWO SIDES

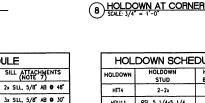

HOL	DOWN SCHE	DULE
HOLDOWN	HOLDOWN STUD	HOLDON
HTT4	2-2x	₩
HDU11	PSL 5 1/4x5 1/4	1°
HDU14	PSL 5 1/4x7	1*

PLAN

ALL ANCHOR BOLTS SHALL BE GALVANIZED 1554 (36).

(2)

1'-0"

(4) INTERIOR FOOTING GRID 2

HOLDOWN SEE FDN PLAN

HOLDOWN BOLT

#6 CONT

SLAB REINF IOP OF SLAB EL SEE PLAN

2'-0

2-#6 CONT

16 OC 2'-0

SHEARWALL SEE SHEAR WALL SCHEDULE

SLAB REINF

TOP OF SLAB

NAILING

HOLDOWN PER PLAN

2. NAIL DOUBLE 2X STUDS TOGETHER WITH 10d AT 4° ON CENTER STAGGERED.


HOLDOWN

BOLT DIA.


3. SIMPSON HARDWARE INSTALLED PER MANUFACTURER'S INSTRUCTIONS.

(12) HOLDOV SCALE: NTS




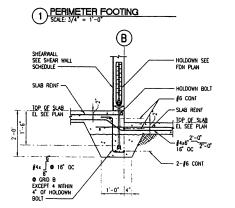



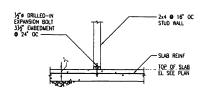

9 NON-SHEAR BEARING WALL
SCALE: 3/4" = 1'-0"

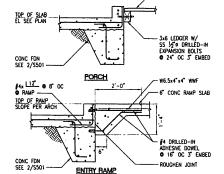


4 1 -0


NOTE: PROVIDE CONTROL OR COLD JOINTS AT 16'-0" OC MAXIMUM EACH WAY IN SLAB ON GRADE.

NTERIOR FOOTING GRID C

(10)	PORCH/	RAMP	то	FOUNDA	TION
(\mathbf{u})	SCALE: 3/4" =	1'-0"			

11 SHEAR WALL SCHEDULE SCALE: NTS

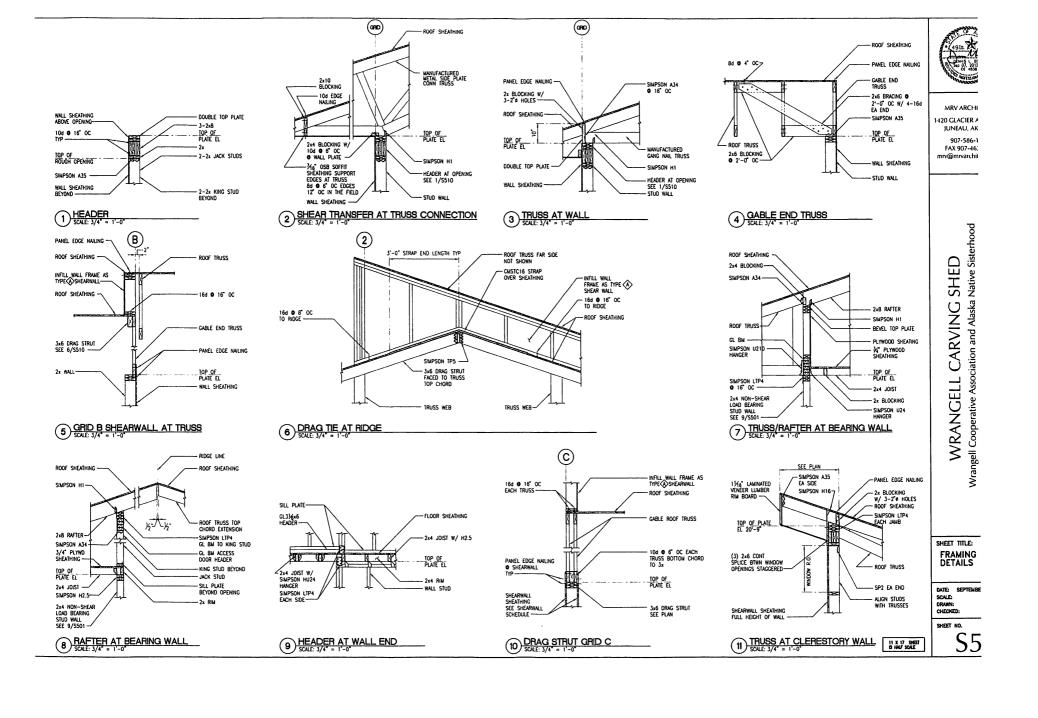

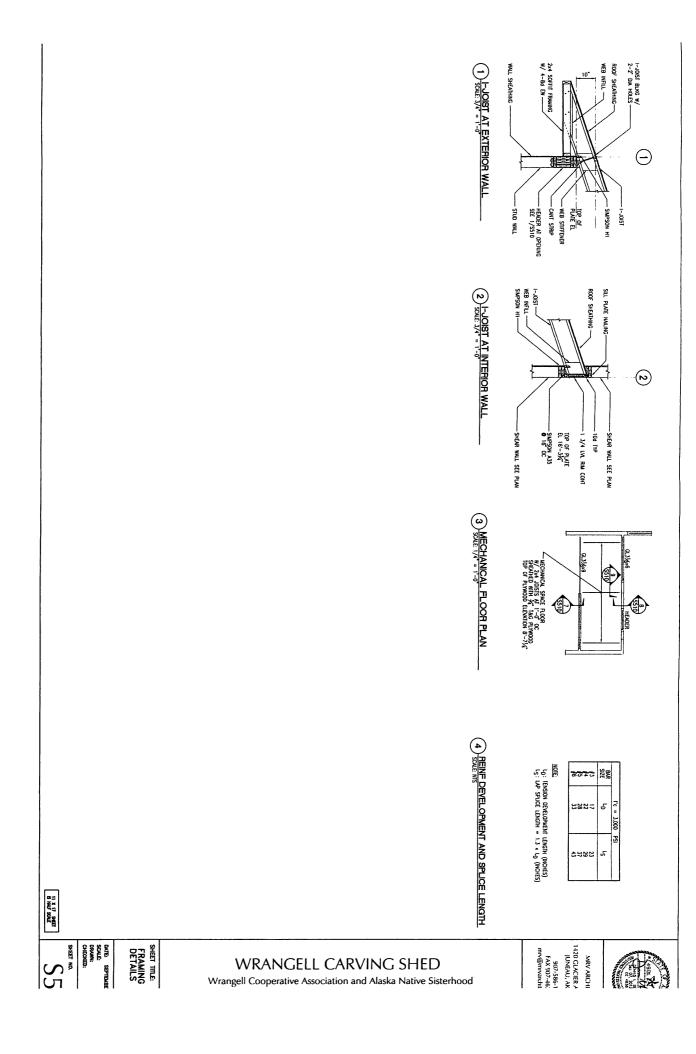

SYMBOLS

-vv	CW HW V	COLD WATER HOT WATER VENT WASTE, SOIL, DRAINAGE	• *	CONSTRUCTION NOTE THERMOSTAT - IMMERSION, ROOM THERMOMETER
		CHECK VALVE	\$	CONTROL SWITCH
		UNION	•	DIAMETER
<u>—</u> Б—		GLOBE VALVE OR ISOLATING BALL VALVE	c .	CENTER LINE
		BALL VALVE	Ø	ACCESS DOOR
	OV	DRAIN VALVE	4 4	MANUAL BUTTERFLY DAMPER
		PITCHED DOWN	. 40	CEILING EXHAUST GRILLE
		REDUCER	040	CEILING SUPPLY GRILLE
 j		CAPPED OR PLUGGED	• N •	RECTANGULAR TO ROUND DUCT TRANSITION
+	co	CLEANOUT	00	EXHAUST DUCT UP, DOWN
•	FC0	FLOOR CLEANOUT	⊠ ⊠	SUPPLY DUCT UP, DOWN

AFF	ABOVE FINISHED FLOOR
č.	COMMON
CFM	CUBIC FEET PER MINUTE
CO	CLEANOUT
DU	DIELECTRIC UNION
DV	DRAIN VALVE
EA	EXHAUST AIR
EC	EXHAUST CAP
EG	EXHAUST GRILLE
ESP	EXTERNAL STATIC PRESSURE
ET	EXPANSION TANK
FCO	FLOOR CLEANOUT
FD	FLOOR DRAIN
HRV	HEAT RECOVERY VENTILATOR
	HOT WATER TANK
IEW	IN ARCHITECTURAL WORK IN ELECTRICAL WORK
KW	IN ELECTRICAL WORK
L KW	LAVATORY
MAT	MIXED AIR TEMPERATURE
MBH	1.000 BTU PER HOUR
NIC	NOT IN CONTRACT
NIM	NOT IN MECHANICAL
OAD	OUTSIDE AIR DAMPER
oc_	ON CENTER
OSA	OUTSIDE AIR
S	SINK
ŠA	SUPPLY AIR
SG	SUPPLY GRILLE
SH	SHOWER
TP	TRAP PRIMER
TSP	TOTAL STATIC PRESSURE
TYP	TYPICAL
T&P	TEMPERATURE AND PRESSURE
VTR	VENT THROUGH ROOF
WCO WC	WATER CLOSET
WCO	WALL CLEAN OUT WALL HYDRANT
WHA	WALL HIDRANI WATER HAMMER ARRESTOR
YCO	YARD CLEANOUT
100	IARD CLEAROUI

MECHANICAL NOTES:

- CODES A REGULATIONS: ALL WORK HEREUNDER SHALL BE STRICTLY IN CONFORMANCE WITH APPLICABLE CODES AND REGULATIONS: ALL WORK SHALL BE IN ACCORDANCE WITH THE 2009 INTERNATIONAL BULLDING CODE, 2009 AND REGULATIONS: ALL WORK SHALL BE IN ACCORDANCE WITH SHALL BULLDING CODE, 2009 AND ALL ELECTRICAL COUNTRY OF BULL BERN HE'LD ALL BEAL ALL SHE'LT HATAL WORK IN DE DOOK WITH OWNAMED SHEET HETAL AND IN ACCORDANCE WITH SMACHA REQUIREMENTS. PROVIDE ALL TESTING REQUIREMENTS FOR RECUMENDED THE ACCORDANCE WITH SMACHA REQUIREMENTS. PROVIDE ALL TESTING REQUIREMENTS FOR RECUMENDED AND WITHOUT AND PROVIDE ALL TESTING RECORDANCE WITH SMACHA REQUIREMENTS. PROVIDE ALL TESTING REQUIREMENTS FOR RECUMENDED AND WITHOUT AND WITHOUT AND PROVIDE ALL TESTING RECORDANCE WITH SMACHA REQUIREMENTS. STUL ALL TESTING RECORDANCE WITH SMACHA RECURREMENTS. STUL ALL TESTING RECORDANCE WITH SMACHA RECURREMENTS.
- INSTALLATION OF PLUMEING SYSTEMS SHALL BE IN ACCORDANCE WITH CROSS CONNECTION REQUIREMENTS OF CHAPTER 6 OF UPC. DOMESTIC WATER PRING SHALL BE TYPE L COPPER. ADJUST AND SET TEMPERING VALVE TO DELACE I 15F HOT WATER 10. FOR THE WATERING.
- VENTILATION: MECHANICAL VENTILATION IS TO BE PROVIDED AS SHOWN HEREUNDER AND AS REQUIRED BY MIC. VENTILATION IS TO BE PROVIDED BY MICH.—I WHICH IS TO OPERATE CONTINUOUSLY AT MEDIUM SPEED UNILESS THE REJUTE HAMBORY CONTROLLER OVERROLES THE SPEED. TEST AND BALANCE SYSTEM, PROVIDE STANDARD ADJUSTMENT LOS.
- 4. INSULATE ALL DOMESTIC WATER PPING, FITTINGS, AND VIAVES WITH 1—INCH THICK PREFORMED FIBERGLASS INSULATION WITH ALL PURPOSE TAME RETURBANT JUNCET AND PIC COVERS. INSULATE VERT PIPING FOR UST FIVE FEET PRIOR TO ROOF PENETRATION AND IN COLD ATTIC SPACE SAME AS DOMESTIC PIPING. INSULATE ALL DUCTWORK IN COLD ATTIC SPACES AGONE TOLETS WITH 1—1/2 INCH THICK FLEDBLE FIBERGLASS WITH FOIL VAPOR BARGRET PACING, SELVE PAR OB DOCT DISALIAND JOHNS.
- 5. HEATING IS BY ELECTRIC HEATING UNITS; SEE ELECTRICAL DRAWINGS.
- 6. FIRE SUPPRESSION: PROMDE A DRY PIPE SPRINGLER SYSTEM FOR ENTIRE FACILITY MEETING NFPA 13 AND STATE OF ALSAYA REQUIREMENTS. SPRINGLER ALL AREAS INCLUDING COLD ATTIC SPACETE, COSPONIONET CONTROLATION. IN COLOR SHOP DAWNINGS, PRODUCT GOAR AND COLOUR TIONS FOR APPROVAL TO PROJECT MANAGES. AND ASSESSION OF SPRINGLER SYSTEM UNDO COUPLETION. IT EST AND CERTIFY STETAM INCLUDING DAVIGTON PROVIDER AS RECORDED.
- 7. PROVIDE TRAINING FOR ALL MECHANICAL AND SPRINKLER SYSTEMS WHEN COMPLETED.
- PROVIDE DEM MANUALS AND AS-BUILT PRINTS OF MECHANICAL, SPRINKLER, AND CONTROLS SYSTEMS
- 9. PROVIDE ONE YEAR WARRANTY OF MECHANICAL SYSTEMS FROM FINAL COMPLETION DATE.
- 10. PROVIDE A COMPLETE AND OPERATING MECHANICAL SYSTEM AS INTENDED AND SHOWN.

PLUMPING FOURDMENT COURDING

		PLUMBING EQUIPMENT SCHEDULE
EQUIPMENT	DESIGN MANUFACTURER	FEATURES/CONTROLS/OPTIONS
WATER CLOSET, WC	KOHLER AMERICAN STANDARD	FLOOR MOUNTED PRESSURE ASSIST TANK TIPE. WITEOUS CHINA. ELONGATED BOWL WITH OPEN FRONT SEAT AND CHECK HINGES. 17-1/2" HIGH BOWL, JAN COMPLIANT. COORDINATE TRIP LEVER LOCATION FOR ACCESSIBILITY AND ADA REQUIREMENTS. 1/2-INCH IPS WHEEL HANGLE ISOLATION VALVE AND TLEUBLE RISER.
LAVATORY, L	KOHLER DELTA (FAUCET TRIM)	WALL MOUNTED 21's 16" WITEOUS CHON LANGORY. STEEL SUPPORT HANGER, 4-INCH FAUCET CENTERS, GRED TYPE STRAMER WITH OFFSET WASTE. TWO SUPPORT BY ONLY SOUR SOUR SHOW HAVE THEN CARRIDEDS. 3-INCH LONG SPOUT. SOUR BOSOD WITH DIRECUL FINISH. FLOW COMPRIOL AGENCIE, 20 GPU. INCHIES WITH VINEOUS CHAN SHROUD COVERING ALL PIPING. AND COMPLIANT. 1/2-INCH LANGORY.
SINK, S	ELKAY JUST DELTA (FAUCET TRIM)	SINCLE COMPARTMENT STANLESS STEEL SINK, SELF-RIMAING, LEDGEBACK, 18 GAGE FULLY UNDERCONTED, PREPUNCHED 18 GAGE STANLESS STEEL. 25 '22 '3-12' 6 EP. CRUINGOUS STRAINER AND OFFSET WASTE. SINKEL GOOSDELECK FAUCET (6-1/2 INCH REACH, 9-1/2 INCH DECAL REARMOR), SOULD BRASS BODY WITH CHROME FINISH. FLOW CONTROL AFRANCO, 2 OPH. 1/2-NCH 19 SEN WHELE HANDLE SINCH WAVE NO FLEXIBLE RISSER, WITES BLOWE FAUCET HANDLES WITH QUARTER TURN CHRITIDGES. ADA COMPLIANT. INSULATION SHIELDS INSTALLED ON HOT, COLD WATER, AND MUSTE PIPMO BELOW LANTORY.
SHOWER, SH-1	LASCO AQUABATH (C4136BF) POWERS HYDROGUARD (E700)	SINGLE PIECE UNIT TO PIT IN A 41"X37" ROUGH OPENING. INCLUDE ANTIBACTERAL SHOWER CURTAIN, NOOKS, ROD, ADJUSTABLE HEIGHT SHOWER HZAD, AND DRAWN. PESSURE BALANCING/TEUPPERATURE LUITING MINING VALVE. ADA COUPATIBLE, INCLUDE OPTIONAL THRESHOLD DAM. COORDINATE CONFIDENTION OF ADA PIXTURE WITH ACTUAL LOCATION. COORDINATE RICESSING OF FIXTURE IF APPLICABLE.
FLOOR DRAIN, FD	ZURN JOSAM	O" DIMIETER
FLOOR SINK, FS	ZURN JOSAM	PORCELAIN ENAMEL 4"x8"X8" DEEP FLOOR SINK WITH SECONDARY STRAINER. 3" OUTLET. 4" SUMP DEPTH. HALF GRATE. WITH TRAP PRIMER CONNECTION.
WALL HYDRANT, WH	ZURN JOSAM	3/4" NON-FREEZE TYPE IN RECESSED BOX, WITH INTEGRAL VACUUM BREAKER.
HOT WATER TANK, HWT-1	STATE ES6 40 DOCT	40 GALLON, GLASS LINED, 4500 W ELEMENT, 240 VOLT, SINGLE PHASE, HIGH EFFICIENCY, TALL MODEL, 2-1/2" THICK FOAM INSULATION, ANODE ROD, T&P RELIEF VALVE. ENERGY FACTOR OF 0.83.
DRINKING FOUNTAIN, DF-1	HAWS ELLER	DUAL DRINKING FOUNTAIN, ROUND BOWLS, ADA COMPATIBLE, ADA APRON, WALL BRACKET IF REQUIRED.
EXPANSION TANK, ET	AMTROL THERM-X-TROL ST-5	FOR POTABLE WATER AND THERMAL EXPANSION. 2 GALLON VOLUME.
THERMOSTATIC TEMPERING VALVE, TV	POWERS MM431	TEMPERATURE ACTIVATED MIXING VALVE, INTEGRAL STOP CHECKS.

FAN SCHEDULE

[QUIPMENT				MANUFACTURER AND MODEL	MIN. KP	VOLTS/ PHASE	FEATURES AND ACCESSORIES
ľ	(RV	BUILDING VENTILATION	900/900	0.4° ESP	LIFEBREATH 1200	(2)1/4 HP		MODULAR ALMINIM HEAT RECOVERY COIL FOR CROSS FLOW EXCHANGE. WASHABLE FILTERS ON OSA AND EA. TWO MOTORS, DOUBLE SHAPTS. 3 SPEED BLOWER CONTROL. CONDENSATE DRAIN PAN/CONNECTIONS. DEFROST CONTROL TO INTERRUPT SURPLY FAN OPERATION. REDOTE WALL MODULATED DEPUMBIESTAY.

VENTILATION EQUIPMENT SCHEDULE

EQUIPMENT	MANUFACTURER	MODEL	CAPACITY/SIZE (INCHES)	FEATURES/CONTROLS/OPTIONS
EXHAUST GRILLE, EG	TITUS	350FL	SEE SCHEDULE	STEEL BORDER, 3/4" SPACING, 30 DEGREE BLADES, 4-WAY DISCHARGE. OPPOSED BLADE DAMPER.
SUPPLY GRILLE, SG	TITUS	300RL	SEE SCHEDULE	STEEL 4-WAY ADJUSTABLE DISCHARGE. OPPOSED BLADE DAMPER.
EXHAUST & INTAKE CAP	CARNES	GI	18x18	LOW CONTOUR, RECTANGULAR TYPE. HOOD OUTLET FREE AREA TO BE MINIMUM TWICE THROAT AREA.
HEATING COIL, HC-1	NEPTRONIC	DF C100H	10.0KW 18x12x8	DUCT MOUNTED, RECTANGULAR TYPE, AIR FLOW SWITCH, 800 CFM, 350 FPM VELOCITY, 240 VOLT SINGLE PHASE, ADJUSTABLE SUPPLY AIR THERMOSTAT SET AT 65F.

DIFFUSER AND GRILLE SCHEDULE

) :	SUPPLY CEILING DIFFUSER/WALL GRILLE EXHAUST GRILLI						£		
ROOM	MARK	NUMBER	SUPPLY CFM	FACE SIZE (INCHES)	NECK SIZE (INCHES)	WARK	NUMBER	EXHAUST CFM		NECK SIZE
MEN RESTROOM	-	-	-	-	-	EG		120	8x8	8x8
RROOM	-	-	-	-	-	EG	1	60	6×6	8×6
CARVING SPACE	SG	2	175	14x6	14x6	EG	2	150	12x6	12x6
TRAINING	SG	1	200	14x6	14x6	EG	1	120	12×6	12x6
OFFICE	\$G	1	100	6x6	6×6	-		-	-	-
TOTEM ROOM	SG	2	125	12x6	12×6	EG	2	150	12×6	12×6
	T									

DRAWING INDEX

Sheet Number	Sheet Title				
M001	SYMBOLS & SCHEDULES				
M101	FOUNDATION PLAN				
M201	FLOOR PLAN				
M202	ENLARGED PLANS				
M300	PLUMBING DIAGRAM				
M301	DETAILS				

MURRAY & ASSOCIATES, P. C. CONSULTING ENGINEERS

P O BOX 21081 TEL: 907 750-6151 JUNEAU, ALSKA 88502 FAX: 907 750-6182

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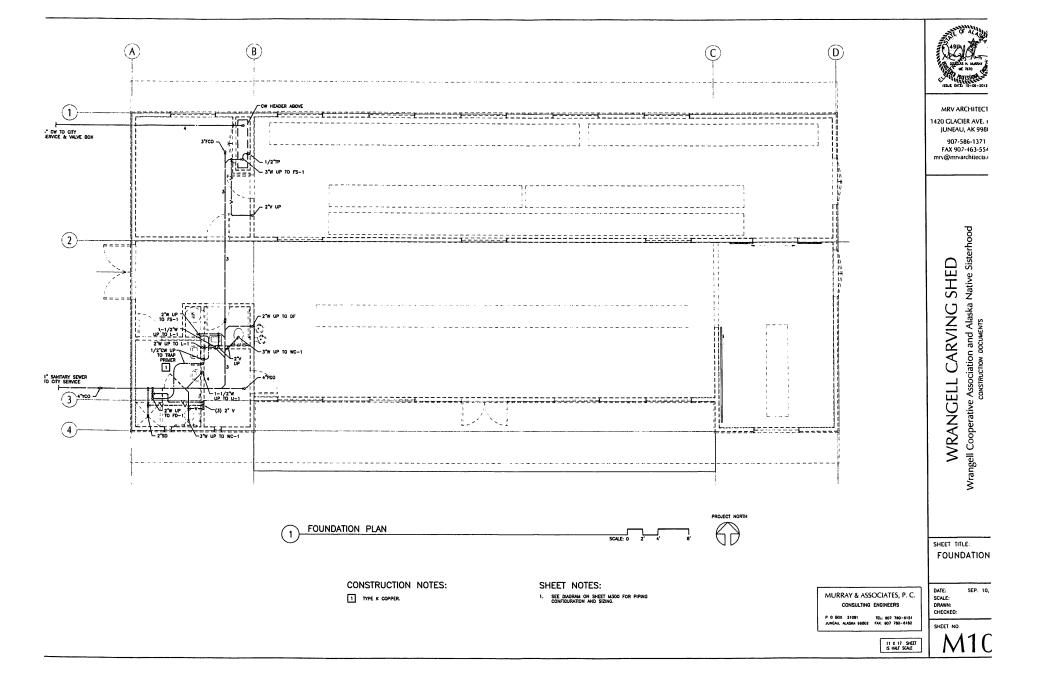
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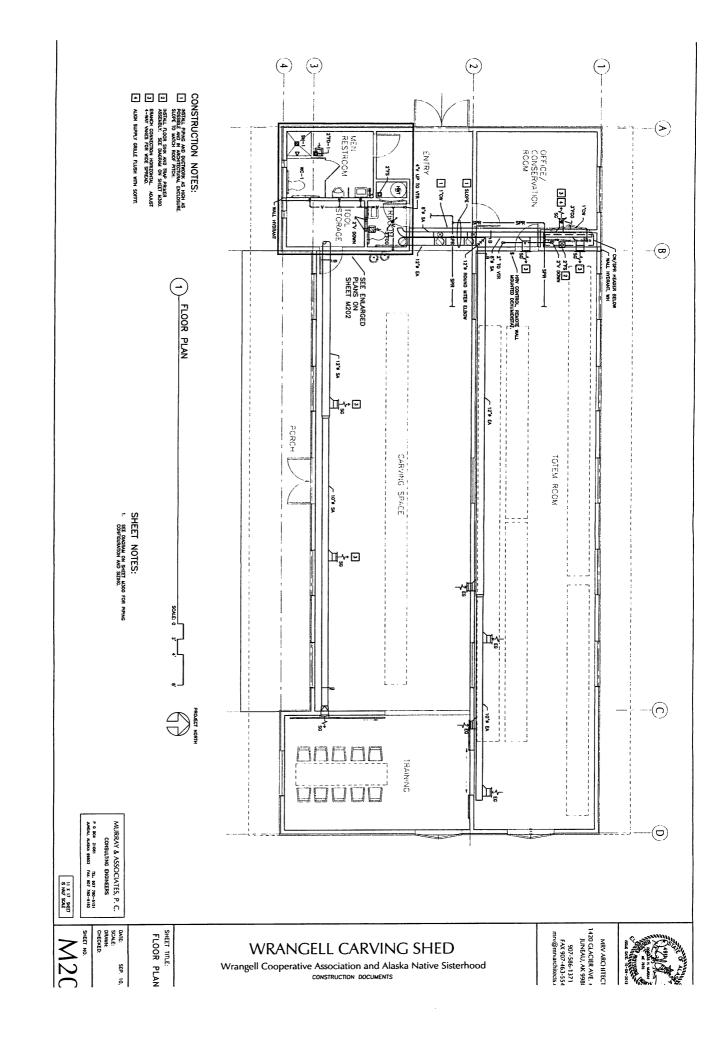
907-586-1371 FAX 907-463-554 mrv@mrvarchitects.c


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SHEET TITLE: SYMBOLS & SCHEDULES

SEP. 10,







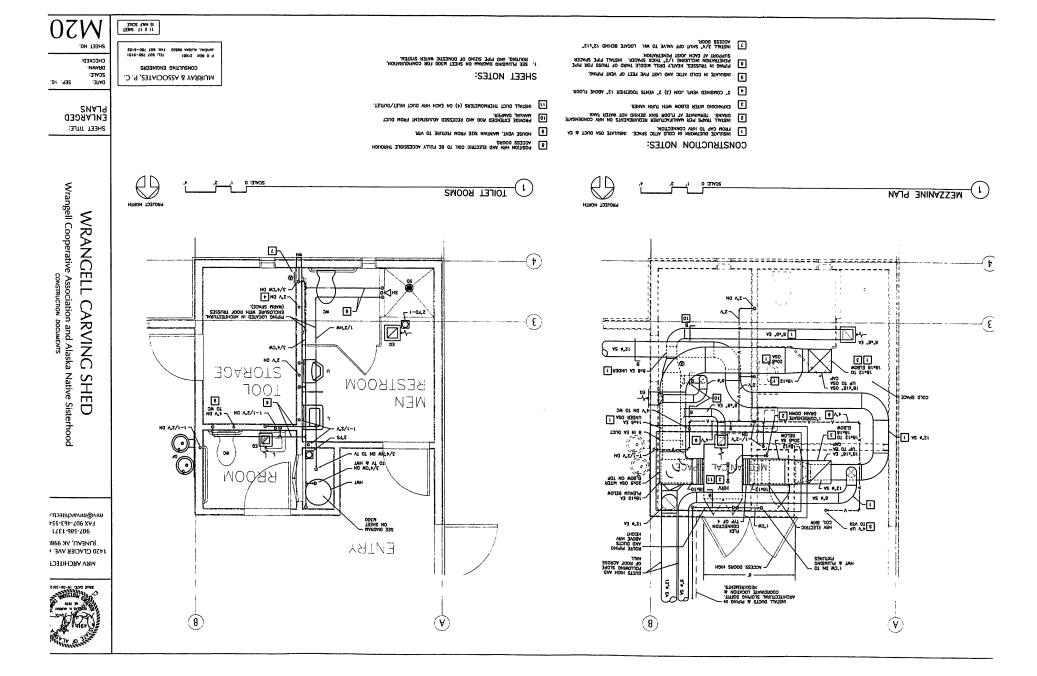

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Wrangell Cooperative Association and Alaska Native Sisterhood construction becuments WRANGELL CARVING SHED

SHEET TITLE: PLUMBING DIAGRAM

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MURRAY & ASSOCIATES, P. C. CONSULTING ENGINEERS

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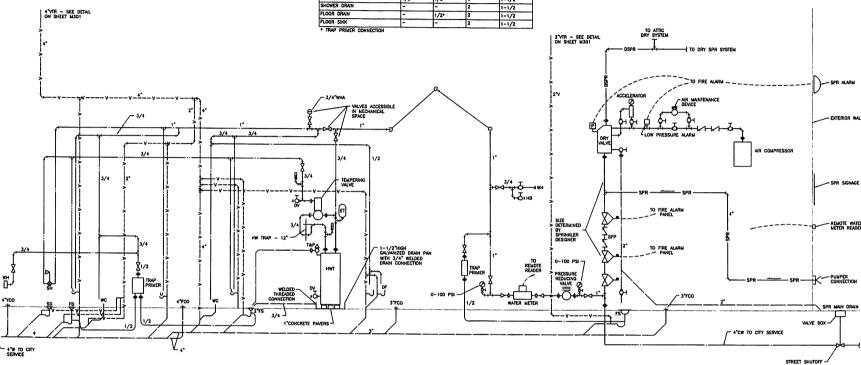
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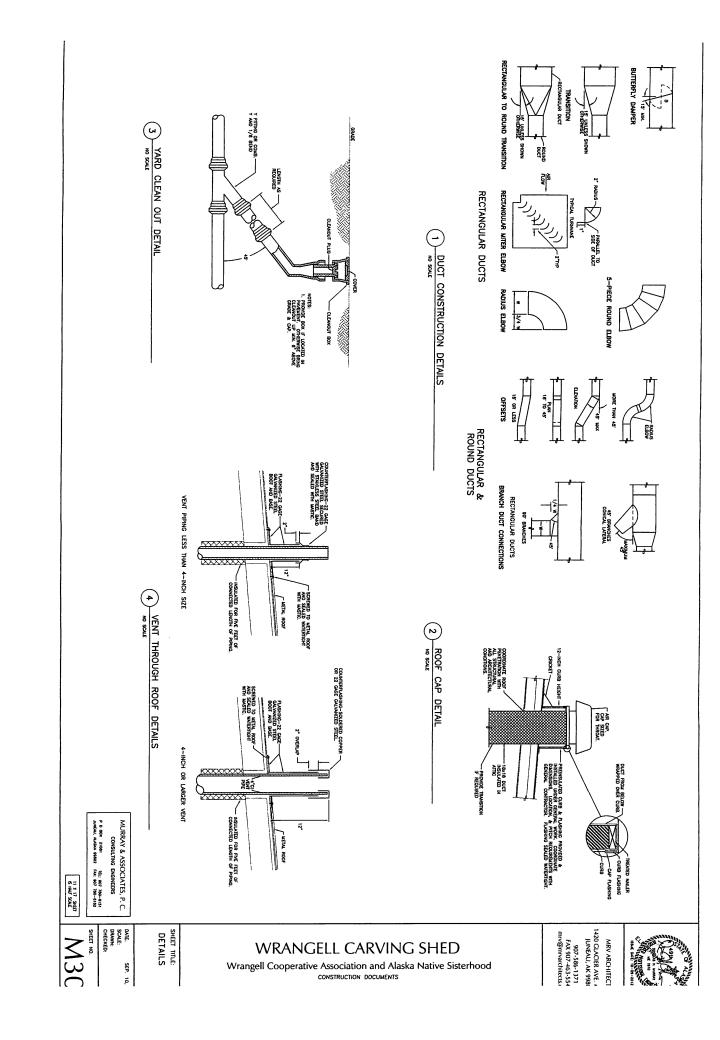
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PLUMBING FIXTURE CONNECTION SCHEDULE

FIXTURE	HOT WATER	COLD WATER	WASTE	VENT
WATER CLOSET, WC	T-	3/4"	3	2
LAVATORY, L	1/2	1/2	1-1/2	1-1/4
SHOWER SH	1/2	1/2	2	1-1/2
DRINKING FOUNTAIN, DF (2)	-	1/2	1-1/4	1-1/4
URINAL, U	-	1.	2	2
SINK, S	1/2	1/2	2	1-1/2
SHOWER DRAIN	-	-	2	1-1/2
FLOOR DRAIN	1-	1/20	2	1-1/2
FLOOR SINK	-	1-	2	1-1/2



WATER AND SPRINKLER HEADER PIPING DIAGRAM NO SCALE



DUPLEX RECEPTACLE: 19" AFF, UON RAIGED HEIGHT RECEPTACLE: 48" AFF, UON CONDUIT w? AUG CONDUCTORS, UON BLASHES DENOTE QUANTITY OF CONDUCTORS IF NOT TWO. SHARED NEUTRALS SHALL BE *0 AUG LEGEND

CCLPANCY BENBOR WALLBOX FOUNTED

DIBCONNECT BUITCH F - FUBED

TELEPHOXE/DATA RECEPTACLE: 18" AFF, UON TELEVISION RECEPTACLE: 18" AFF, UON LECTRIC COVE HEATER, WATTAGE NOTED

HAVIAL PAIL STATION
SHOCE DETECTOR 195" UON ATTPER SUNTCH Ou BUITCH

IR COMPRESSOR
BOYS FMISHED FLOOR
LECTRIC COVS HEATER

PLOT LIGHT BUITCH, 48" AFF, UON HREE OF FOUR WAY SWITCH, 46" AFF, LON OUBLE DUPLEX RECEPTACLE: 18" 4FF JON

THE MOINT EXIT BRINGHT DOWNIGHT PAGENCY LIGHT JORESCENT SURFACE LIRAP

HOTOR CONECTION BLAW + NO STARTER • • MANUAL STARTER • • MAGNETIC STARTER

MANETIC STARTER MUAL STARTER

RE ALARM CONTROL PANEL

ELECTRIC MAINS CONTROLS
EAUP UNI PERSONNE DALLAST
ELECTRIC UNI MAINE
FREE ALAST CONTROL PAUEL
GROUND FALLE CIRCUIT INTERSUPTER
GROUND

HEATING COIL
HAMP-CEP-MITO BUTCH
HEAT RECOVERTY VENTILATOR
HOT WATER TAK
HOT WATER TAK
HOTANG CONTACTOR
LIGHTING CONTACTOR
LIGHTING

PAIN DESTRUTION PAREL
NOT MATCHED
NOT MATCHED
PROTORLECTRIC CELL
RECEPTAGE
TIPE GLOCK
THERE CACK
THERE TRAINIATION BOARD
NOT REATER

ERWOE NOTED

TROBE NOTBICATION APPLIANCE

ORNOTROBE NOTFICATION APPLIANCE

EATHERPROOF HORN NOTFICATION APPLIANCE

Total Comected Load for the facility is 55.8 kVA (133.5 Amperes). Actual Denand Load for the facility is 42.6 kVA (183. Amperes).

NOTES and SPECIFICATIONS

Provide all eath as shown on the detailed, and described in the specification, and near for complete and forcefold restaurce, to use of the standard construction. All restaul shall be approved by transfer the characterisk standard construction. All restauts shall be approved by transfer to the characterisk standard construction. All restauts shall be approved by

All work well comply with the treat approved settlions of in the National Rear Protection Association Codes (NFDA). The National Rear Protection Association Codes (NFDA) the international Building Codes (RED) the various research Accessibility Managina (MAB).

All applications Faces in Accessibility Managina (MAB).

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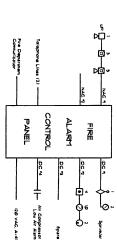
The convictor shill coordinate hylatistics of the poor, integrates and cable stampling services with the entire guillation and build comply with our integritement. Poor a territor and provinced by the City of trappill flavorical Department to the service explanest and provinced by the City of trappill flavorical Department to the service explanest and provinced and provinced to the control of Coppets. Book and control of Coppets and provinced to the control of Coppets and the cop

All conductors wall be copper. Conductors in receiving whill have figs TheVTHAN insulation for incide works and figs Archaff of reference work. Tighes and and the Catalogistics for interior work where approved by the local authority, the Owner and the NEC. easy systems whill be ETM for feader sesphone and data circuits and rigid steel for the seed service assured, Scheoolie 80 PrC is acceptable for underground has arms steed by the NEC and the local utilities.


Dones wall be seed with appropriate planter ridgs. All wing devices swall be specification grade, screw conscited, white with national wite signor plates. Provide a sanual or sagnetic stanter/disconnect (as shown or required) for all notor loads.

Provide in addressable fire alum system locating a control parel with testing scalaus, a digital commission from older in such plus station, provide fire not supposed. The provide a did test categorie, and collection applicate from visitories, from soci strongs. The price a contraction strongs are consciented to the state of the critical fielding the fire Assert Control Princis of decisions and control princis of decisions of the control principal control co

Provide telephone and data receptable as shown. For each sell recited receptable provides in deep 4 injuries box, angle gong paster ring and a 3.44 conduit to the accessible still space above the Part floor or directly to the desphone Termination Board (TTB). Provide CAT 6 cabing froe each box to the TTB.



FIRE ALARM RISER DIAGRAM

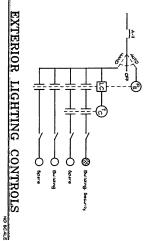

HHHh | SINGLE LINE DIAGRAM 3. RG6 W/3/ 500 Cho on () , 004 (F) (<u>]</u> - Concrete Encased Electrode
- Underground thate Pipe
- (2) 3/4" x 40" Ground Roos 120/240V, I-Phose, 400 Arp Meter Base Jith (1) 400/2 (Panel A) Bevice Discorrect Breaker, all NBMA 3R Building Steel

SHEET TITLE:

IS HAT SOME

DATE: NOVEMBER SCALE: LEGEND, I SINGLE LI DIAGRAMS DRAWN: CHECKED SHEET NO E1

WRANGELL CARVING SHED Wrangell Cooperative Association and Alaska Native Sisterhood

1420 GLACIER A JUNEAU, AK 907-586-1 FAX 907-46. mrv@mrvarchit MRV ARCHI



800 GLACIER AVENUE, 901TE E JUNEAU, ALASKA 99801-1852 PHONE: 463-6171 FAX: 586-6716 G-mail: PGOrman®GCinat

ENGINEERS

SHEET NOTES

- Provide comection to all power and mechanical devices and equipment shown. Include starters, as noted, associated with mechanical equipment. Refer to the Panel Schadule on Shaet E600 for circuiting.
- Pull conductors for the circuits as shown in the Paral Schedule. All runs shall include a single and separate equipment grounding conductor, sized per the NEC.
- Coordinate the installation and connection of all mechanical, architectural, and Owner-funished equipment and receptacles with the other trades, architectural dirabilings and manufacturer's requirements. Ensure the proper mounting heights, electrical configurations and clearances with other equipment and terminations.

1420 GLACIER / JUNEAU, AK

CORMAN Engineers

BOO GLACIER AVENUE, SUITE E JUNEAU, ALASKA 99801-1852 FHONE: 463-6121 FAX: 586-6216 e-mail: pgorman@gcinet

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907-586-1 FAX 907-46


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Wrangell Cooperative Association and Alaska Native Sisterhood WRANGELL CARVING SHED

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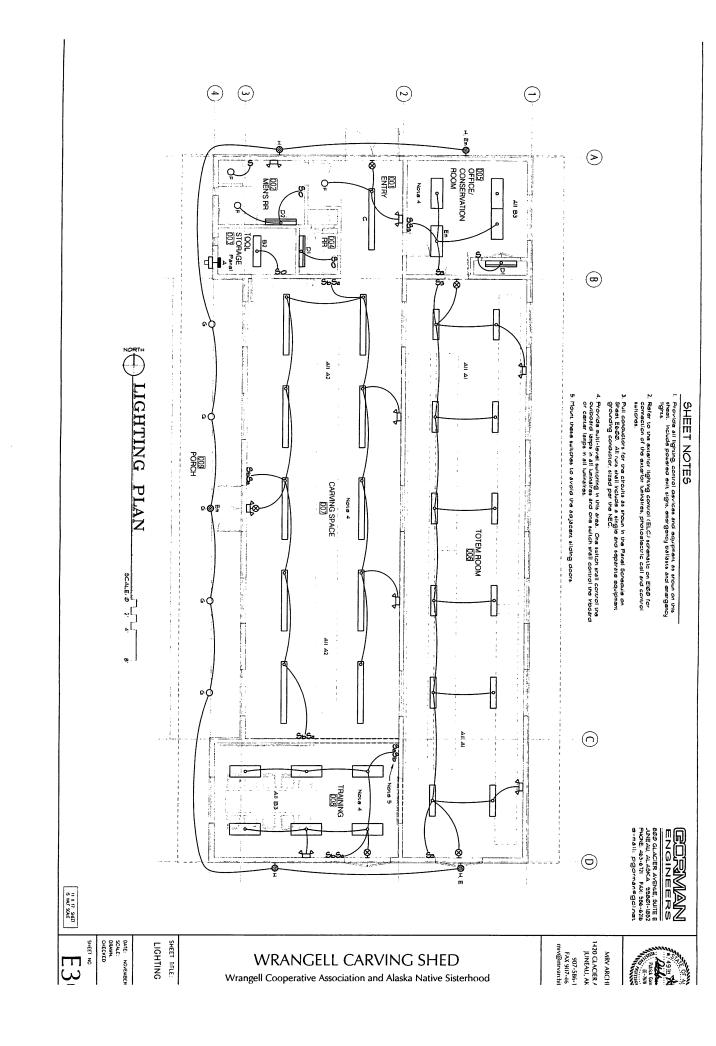
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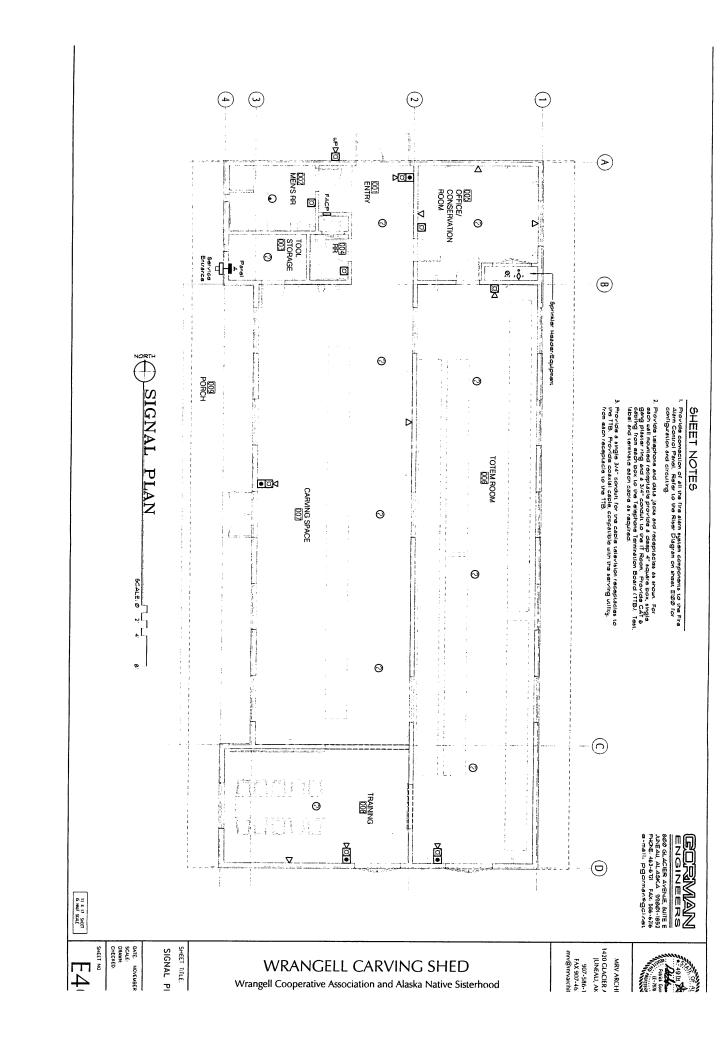
SHEET NO



POWER PLAN

5CALE. Ø 2' 4'

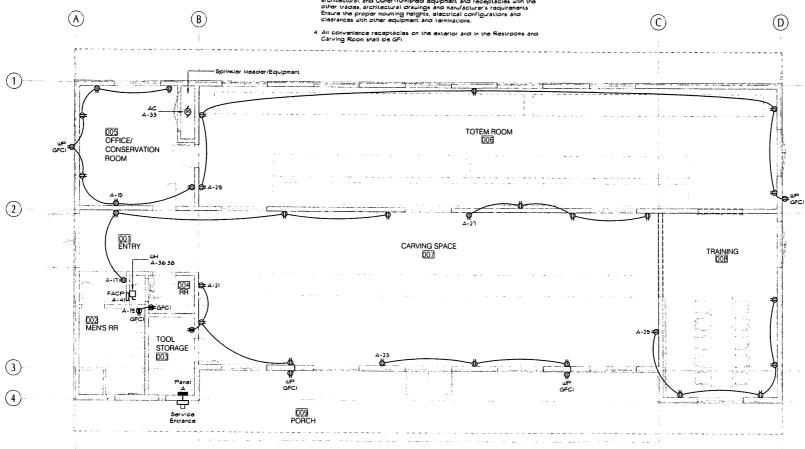



SHEET NOTES

- Provide comection to all electrical heating equipment and controls as show, include wall mounted thermostats, as noted, associated with heating equipment. Refer to the Paral Schedule on Sheet E600 for circuiting.
- Pull conductors for the circuits as shown in the Panel Schedule. All runs shall include a single and separate equipment grounding conductor, sized per the NEC.



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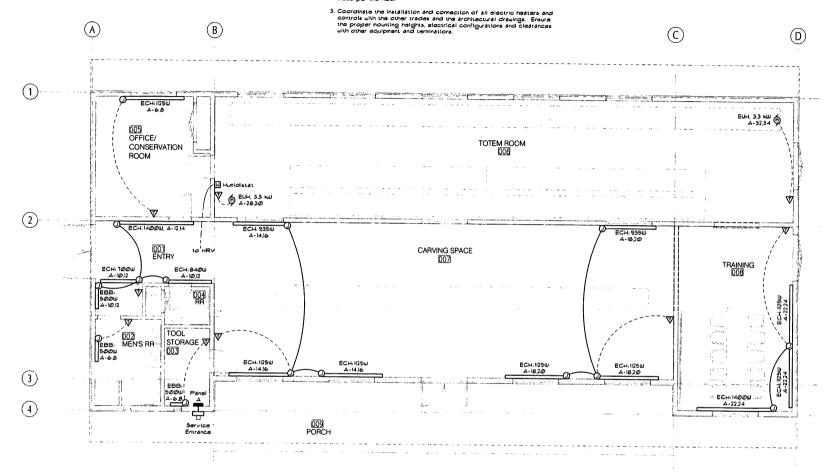
mrv@mrvarchit

Wrangell Cooperative Association and Alaska Native Sisterhood WRANGELL CARVING SHED

SHEET TITLE: HEATING I

DATE: NOVEMBER SCALE: DRAWN: CHECKED.

SHEET NO



HEATING PLAN

SCALE: 0 2 4

11 X 17 SHEET IS HALF SCALE



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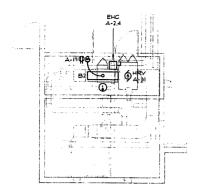
WRANGELL CARVING SHED

Wrangell Cooperative Association and Alaska Native Sisterhood

SHEET TITLE. SCHEDULE MEZZANIN

PLAN DATE: NOVEMBER SCALE: DRAWN: CHECKED:

SHEET NO



MEZZANINE PLAN -	<u>.</u> _		
SCALE: 0	2'	4'	a.

Panel A		SIZE 400 amps		VOLTS/PHASE 120/240, 1P, 3W		MAIN LUGS ONLY		MOUNT / LOCATION SURFACE / TOOL STORAGE	SHORT C			
	WIRE		BRKR						BRKR		WIRE	Т
CKT	Qty/		Amp/		K	٧	_ A		Amp/		Qtv/	cĸ
	Size	CIRCUIT DESCRIPTION	Pole	CKT	Α		В	č	Pole	CIRCUIT DESCRIPTION	Size	
1	2/#12	LTG - Entry, Office, Restrooms, Storage	20/1	12	6.2			5.0	60/2	Electric Heating Coll (HRV), 10 kW	3/#8	1 2
3	2/#12	LTG - Totem Storage	20/1	1.2			6.2	5.0				14
5	2/#12	LTG - Carving	20/1	16	2.7			1.1	20/2	Electric Cove & BB Htrs - Office, RR, Tool	2/#12	1 6
7	2/#12	LTG - Carving	20/1	1.2			2.3	1.1		1 @ 1125W, 2 @ 500W		1 6
9	2/#12	LTG - Training	20/1	1.0	2.7			1.7	20/2	Electric Cove Heaters - Entry	2/#12	10
11	2/#12	LTG - Exterior	20/1	10			2.7	1.7		1@1400W, 1@840W, 1@700W, 1@500		12
13	ll	Spare	20/1		1.8			1.8	20/2	Electric Cove Heaters - Carving North	2/#12	14
15	2/#12	REC - Office, Exterior	20/1	1.4			3.0	1.6		2 @ 1125W, 1 @ 935W		1
17	2/#12	REC - Entry, Carving E, Totem W, Mech	20/1	1.0	26			16	20/2	Electric Cove Heaters - Carving South	2/#12	118
19	2/#12	REC - Restrooms	20/1	1.5			3.1	1.6		2 @ 1125W, 1 @ 935W		20
21	2/#12	REC - Carving NW, Tools, Exterior	20/1	10	2.8	١ ١		1.8	20/2	Electric Cove Heaters - Training	2/#12	1 -
23	2/#12	REC - Carving W. Exterior	20/1	0.8			2.6	1.8		1 @ 1400W, 2 @ 1125W		24
25	2/#12	REC - Carving S. Training	20/1	1.0	2.7	- [1.7	20/2	Electric Unit Heater, 3.3 kW - Totem North	2/#12	26
27	2/#12	REC - Carving East, Totem Storage	20/1	0.8			2.5	1.7				26
29	2/#12	REC - Totern Storage, Exterior	20/1	1.2	2.9			1.7	20/2	Electric Unit Heater, 3 3 kW - Totem South	2/#12	30
31	2/#12	Heat Recovery Ventilator, HRV-1	20/1	1.0			2.7	1.7		•••		32
33	2/#12	Air Compressor	20/1	12	3.5	- 1		2.3	30/2	Water Heater	2/#10	34
35		Spare	20/1			- 1	2.3	23				36
37	1 1	Spare	20/1		0.0				1 1			1 32
39	1 1		l				0.0					40
41	2/#12	Fire Alarm Control Panel	20/1	0.5	0.5	ı	••					42
		TOTAL CONNECTED LOAD (kVA):	55.8		28.4		27.4			ACTUAL DEMAND LOAD (kVA):	42.0	1.34

NAME	DESCRIPTION	MANUFACTURER	MODEL / SERIES	WATTAGE	LENGTH	CONTROL
688	Electric Hydronic Baseboard Heater	Q-Mark	HBB504	500	26*	Wall-mount Thermostat
ECH	Electric Cove Heater	King Electric	KCV2407	700	59°	Wall-mount Thermostat
			KCV2409	840	71*	Wall-mount Thermostat
			KCV2410	935	83*	Wall-mount Thermostat
			KCV2412	1,125	94*	Wall-mount Thermostat
		i	KCV2415	1.400	118"	Wall-mount Thermostat
EUH	Electric Unit Heater	Altken	AUH-320-SA	3,300		Wall-mount Thermostet

	LUM	NAIRE SC	HEDU	LE		
TYPE	DESCRIPTION	MANUFACTURER	LAMP(8)	REMARKS		
A1 A2	Fluorescent heavy-duty industrial wi20% uplight parabotic reflector, steel body, high-goas baked write enamed finan, full-depth end plates, wire guards, electronic balasts.	Lithonia PV 232 GEB 10PS PCEP WGAFPV	(2) F32T8/SP41/ECO/C	AZs are tandem-mounted A1's Electronic ballasts Surface mount A1's. Chain hang AZs at 9'-0" AFF. Spit switch AZs where/as noted. Equip with emergency ballast as noted.		
82 83	Fluorescent surface modular with wraparound tell bottom low brightness high impact acrylic refractor, electronic bakest	Lithonia AW 2(3) 32 AR GEB 10PS	(2). (3) F32TB/SP41/ECO/C	Electronic ballests. Split switch B3's where noted Equip with emergency ballast as noted.		
c	Fluorescent indirect/direct pendant with standard diffusor, steel housing, die-cast end ceps, parallet white steel baffies, electronic ballast, dust cover	Peedess 'Cerra 10' 10CRM4 232 WHR SPR OPD SBL 120 GEB10 DU SCEP	(2) F32T8:SP41/ECO/C	Electronic battasts. Firitish by Architect. Mount at 11'-0" AFF		
D1 D2	Fluorescent wall mount with brushed aluminum body, acrylic pramatic diffusers, brushed aluminum end caps, electronic ballast	Lithonia W 1(2)2 32 MVOLT GEB 10RS AE	(1), (2) F32TB SP35/ECO/C	Electronic balast. Mount above mirror in Restrooms.		
Е	Emergency light with white high impact plastic nousing, polycerbonate domes, adjustable temps	Lithonia ELM2	(2) 5.4W Krypton			
F	6" housing with air-tight construction, IC rated, LED module, regressed tens, white dis-cast beffle and timing	Halo H750ICAT, ML706830 & 492PS06	(1) 13 8W LED module	Energy Star rated		
G	6" compact fluorescent downlight with clear semi- specular low indescent reflector, honzontal lamp, tempered glass prismatic lens, electronic ballast	Lithonia AF 1/32TRT SAR 173	(1) F32TBX B41/A/ECO	Electronic ballosi Equip with emergency bollast as noted		
н	Motel halide wailpack with full cutoff wide-throw optics, corros-on resistant dio-cast aluminum housing, high PF ballast, tempered glass lens, full cutoff visor	Lithonia TWR1C 100M FCV	(1) 100W Meter Halide	Firesh by Architect		
x	Contemporary emergency stat light with dis-cast aluminum housing, brushed eluminum facepiate, stencil face, nickel cadmium battery. LED temps	Lithonis LQC G EL N	LED's	Mount 96" above finished floor, UON		